

THRHA SINGLE FAMILY DWELLING

Douglas, AK

LOCATION MAP



PARTICIPANTS

CLIENT:
TLINGIT-HAIDA REGIONAL HOUSING AUTHORITY
5446 JENKINS DRIVE
JUNEAU, AK 99801
907.780.6868

ARCHITECT / CIVIL ENGINEER:
R&M ENGINEERING-KETCHIKAN, INC.
7180 REVILLA ROAD, SUITE 300
KETCHIKAN, ALASKA 99901
907.225.7917

MECHANICAL ENGINEER:
SAM THORNTON MECHANICAL ENGINEERING
PO BOX 7162
KETCHIKAN, AK 99901
907.220.7849

ELECTRICAL ENGINEER:
EIC ENGINEERS
6927 OLD SEWARD HWY, #200
ANCHORAGE, AK 99518
907.349.9712

CODE REVIEW

PROJECT LOCATION:
TBD

IRC 2012 REVIEW

I. TYPE OF CONSTRUCTION (Chapter 6)

V-B
SPRINKLED - NO

II. USE & OCCUPANCY CLASSIFICATION

R-3, RESIDENTIAL

III. OCCUPANCY SEPARATIONS

1-HR SEPARATION BETWEEN GARAGE & LIVING SPACE ABOVE
20 MIN SEPARATION BETWEEN GARAGE & ADJACENT LIVING SPACES

IV. BUILDING AREA

ALLOWED: UL SF/STORY, 3 STORIES
SPRINKLER INCREASE: NONE
TOTAL ALLOWED: UL SF, 3 STORIES
PROPOSED: 2 STORIES @ 866 SF/STORY (1,732 TOTAL SF)

V. BUILDING HEIGHT

ALLOWED: 40'
PROPOSED: 22'-1" (+/-)

VI. OCCUPANT LOAD

LEVEL	RESIDENTIAL	GROSS SF	LOAD
LOWER LEVEL	RESIDENTIAL	969 GROSS SF / 200	5
UPPER LEVEL	RESIDENTIAL	969 GROSS SF / 200	5
		TOTAL OCCUPANT LOAD	10

ZONING REVIEW

CITY & BOROUGH OF JUNEAU TITLE 49 ZONING REVIEW

LEGAL DESCRIPTION: CHATHAM PLACE LT 1A
PARCEL NUMBER: 2D040-C03-0011

ZONING: Multi-Family (D18)

LOT SIZE: 50,406 SF

COVERAGE:

MAX: 50%

PROPOSED: 3.8% TOTAL (2 BUILDINGS)

BUILDING GROSS AREA: 1,938 SF

BUILDING HEIGHT:

MAXIMUM: 38'

PROPOSED: 22'-1" (+/-)

SETBACKS:

MINIMUM:

Front setback off of Crow Hill Drive (west) is 20 feet
Street side setback off of Crow Hill Drive (north) is 13 feet
Street side setback off of Douglas Highway (east) is 13 feet
Side setback (south) is 5 feet.

PROPOSED:
VARIES-SEE A100 & CIVIL DRAWINGS

PARKING:

MINIMUM: 2 SPACES PER DWELLING UNIT
PROPOSED: 2 SPACES PER DWELLING UNIT

SHEET INDEX

GENERAL		ARCHITECTURAL (CONT.)	
S201	Main Floor Framing	A601	FF&E Scheme2 Plans
G100	Cover Sheet	A700	Details
		A701	Details
		A702	Details
		A703	Details
		STRUCTURAL	
G101	Abbreviations & Symbols	A704	Details
C001	General Notes/Legend/Geotechnical	S100	Structural Notes
C100	Existing Conditions	S200	Foundation Plan
C200	Site, Grading, & Storm Drain Plan	S203	Upper Floor Framing Plan
C200.1	Grading Point Tables	S202	Main Floor Header & Shearwall Plan
C201	Retaining Wall #1 Plan & Profile	S204	Upper Level Shearwall & Header Plan
C202	San. Sewer Line #1 Plan & Profile	S205	Roof Framing Plan
C203	Water Line #1 Plan & Profile	S300	Structural Details
C204	Profiles & Sections		
D100	Details	MECHANICAL	
D101	Details	S301	Structural Details
D102	Details	M001	General Note & Symbols
D103	Details	M002	Abbreviations
D104	Details	M100	HVAC Plan
D105	Details	M200	Drain, Waste, & Vent Plan
		M201	Hot and Cold Water Plan
		ELECTRICAL	
A106	Details	M700	Details
A001	Notes & Wall Types	E001	Legend
A002	Schedules	E101	Main Level Electrical Plan
A100	Architectural Site Plan	E201	Upper Level Electrical Plan
A200	Main Floor Plan	E301	One-Line Diagrams, Details, and Schedules
A201	Upper Floor Plan		
A202	Roof Plan		
A203	Enlarged Plans		
A204	Enlarged Plans		
A205	Stair Plans & Details		
A300	Sections		
A400	Elevations		
A401	Elevations		
A600	FF&E Scheme 1 Plans		

REVISIONS:
Rev #1: 8.28.23

THRHA
Single Family Dwelling

STATUS:

CONSTRUCTION
DOCUMENTS

DRAWN BY: NMG
CHECKED BY: NMG
DATE: 3.6.23
PROJECT #: 222321.10

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SHEET DESCRIPTION:

Cover Sheet

G100

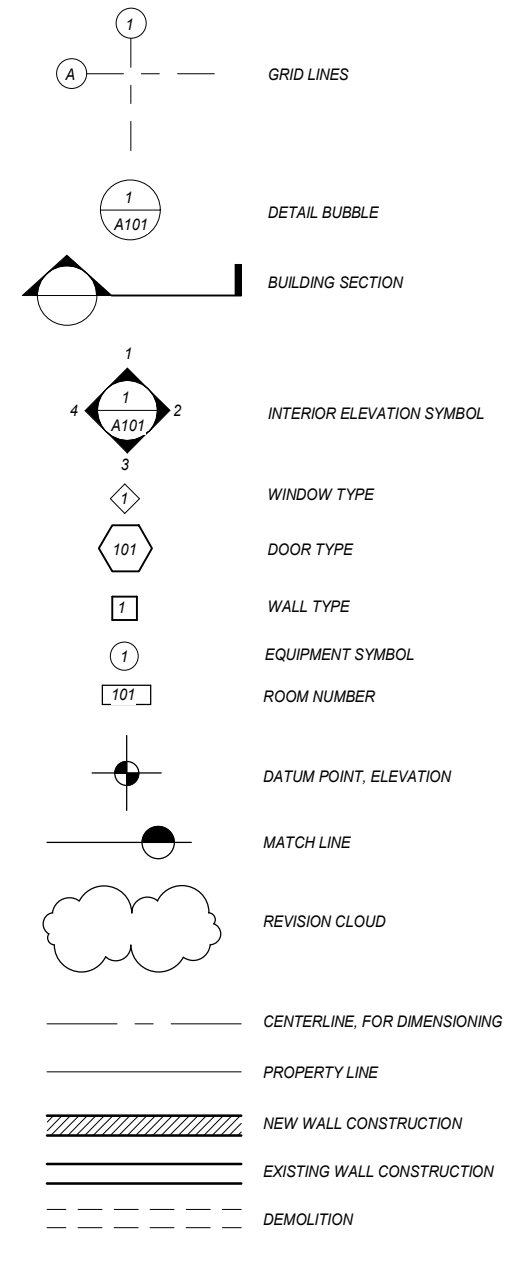
SHEET:

01 of 28

ARCHITECTURAL ABBREVIATIONS

AB	ANCHOR BOLT	F/F	FACE TO FACE	MACH	MACHINE
ABV	ABOVE	F.F	FINISH FLOOR	MAN	MANUAL
ACOUS	ACOUSTICAL	FA	FIRE ALARM	MATL	MATERIAL
ACT	ACOUSTICAL CEILING TILE	FBD	FIBERBOARD	MAX	MAXIMUM
AD	AREA DRAIN	FD	FLOOR DRAIN	MC	MEDICINE CABINET
ADDL	ADDITIONAL	FDC	FIRE DEPARTMENT CONNECTION	MECH	MECHANICAL
ADJ	ADJUSTABLE	FND	FOUNDATION	MEMB	MEMBRANE
AFF	ABOVE FINISHED FLOOR	FDV	FIRE DEPARTMENT VALVE	MET	METAL
AFG	ABOVE FINISHED GRADE	FE	FIRE EXTINGUISHER	MFR	MANUFACTURER
AFS	ABOVE FINISHED SLAB	FEB	FIRE EXTINGUISHER BRACKET	MH	MANHOLE
AL	ALUMINUM	FEC	FIRE EXTINGUISHER CABINET	MIN	MINIMUM
ALT	ALTERNATE	FHY	FIRE HYDRANT	MIR	MIRROR
AP	ACCESS PANEL	FIN	FINISH	MISC	MISCELLANEOUS
APPROX	APPROXIMATE(LY)	FIN GR	FINISH GRADE	MOD	MODULAR
ARCH	ARCHITECT(URAL)	FL	FLOOR(ING)	MTD	MOUNTED
ASPH	ASPHALT	FLASH	FLASHING	MTG	MOUNTING
AUTO	AUTOMATIC	FLEX	FLEXIBLE	MULL	MULLION
		FLR SK	FLOOR SINK		
BD	BOARD	FLUOR	FLUORESCENT	(N)	NEW
BKG	BACKING	FNR	FEMININE NAPKIN RECEPTACLE	N	NORTH
BLDG	BUILDING	FNTD	FEMININE NAPKIN-TAMPON DISPENSER	NA	NOT APPLICABLE
BLKG	BLOCKING	FOC	FACE OF CONCRETE	NAT	NATURAL
BLW	BELOW	FOF	FACE OF FINISH	NIC	NOT IN CONTRACT
BOT	BOTTOM	FOM	FACE OF MASONARY	NO	NUMBER
BRKT	BRACKET	FOS	FACE OF STUD	NOM	NOMINAL
BSMT	BASEMENT	FRPF	FIREPROOFING	NRC	NOISE REDUCTION COEFFICIENT
BTW	BETWEEN	FRZ	FREEZER	NTS	NOT TO SCALE
BURS	BUILT UP ROOFING SYSTEM	FSB	FOLDING SHOWER BENCH		
		FSTNR	FASTENER	OA	OVERALL
CAB	CABINET	FT	FOOT, FEET	OC	ON CENTER
CB	CATCH BASIN	FTG	FOOTING	OD	OUTSIDE DIAMETER
CCTV	CLOSED CIRCUIT TELEVISION	FURN	FURNITURE	OFCI	OWNER FURNISHED-CONTRACTOR INSTALLED
CG	CORNER GUARD	FURR	FURRING	OFOI	OWNER FURNISHED-OWNER INSTALLED
CEM	CEMENT	FUS	FOLDING UTILITY SEAT	OH	OPPOSITE HAND
CER	CERAMIC	FUT	FUTURE	OPNG	OPENING
CER TILE	CERAMIC TILE	FXTR	FIXTURE	OPP	OPPOSITE
CL	CENTERLINE			OVHD	OVERHEAD
CLG	CEILING	GA	GAUGE	PBD	PARTICLE BOARD
CLJ	CONTROL JOINT	GALV	GALVANIZED	PCF	POUNDS PER CUBIC FOOT
CLR	CLEAR	GB	GRAB BAR	PERF	PERFORATED
CMU	CONCRETE MASONRY UNIT	GC	GENERAL CONTRACTOR	PERIM	PERIMETER
CNTR	COUNTER	GL	GLASS	PERM	PERMANENT
CO	CASED OPENING	GL BLK	GLASS BLOCK	PERP	PERPENDICULAR
CONC	CONCRETE	GLULAM	GLUE LAMINATED	PH	PANIC HARDWARE
CONF	CONFERENCE	GLZ	GLAZING	PL	PROPERTY LINE
CONN	CONNECTION	GND	GROUND	PLAM	PLASTIC LAMINATE
CONSTR	CONSTRUCTION	GR	GRADE, GRADING	PLAT	PLATFORM
CONT	CONTINUOUS	GRV	GRAVEL	PLBG	PLUMBING
CORR	CORRIDOR	GYP BD	GYPSPUM BOARD	PLF	POUNDS PER LINEAL FOOT
CRPT	CARPET			PLYWD	PLYWOOD
CSWK	CASEWORK	H	HIGH	PNL	PANEL
CT	CARPET TILE	HB	HOSE BIB	PREFAB	PREFABRICATED
CUST	CUSTOM	HC	HOLLOW CORE	PRKG	PARKING
CW	COLD WATER	HCP	HANDICAPPED	PROJ	PROJECT
		HD	HEAD	PROP	PROPERTY
DBL	DOUBLE	HDBD	HARDBOARD	PSF	POUNDS PER SQUARE FOOT
DEMO	DEMOLISH	HDWE	HARDWARE	PSI	POUNDS PER SQUARE INCH
DET	DETAIL	HM	HOLLOW METAL	PT	POINT
DF	DRINKING FOUNTAIN	HNDRL	HANDRAIL	PTD	PAPER TOWEL DISPENSER
DIA	DIAMETER	HR	HOUR	PTD/R	PAPER TOWEL DISPENSER W/ RECEPTACLE
DIAG	DIAGONAL	HT	HEIGHT	PTR	PAPER TOWEL RECEPTACLE
DIFF	DIFFUSER	HVAC	HEATING, VENTILATION, AIR CONDITIONING, & COOLING	PVMT	PAVEMENT
DIM	DIMENSION			PWR	POWER
DIM PT	DIMENSION POINT	HW	HOT WATER		
DISP	DISPENSER	ID	INSIDE DIAMETER	QT	QUARRY TILE
DIST	DISTANCE	INCAND	INCANDESCENT	QTR	QUARTER
DLV	DOOR LOUVER	INCL	INCLUDING	QTY	QUANTITY
DMPF	DAMP PROOFING	INFO	INFORMATION		
DN	DOWN	INSUL	INSULATION	R	RISER
DR	DRAIN	INT	INTERIOR	RA	RETURN AIR
DS	DOWNSPOUT			RAD	RADIUS
DT	DRAIN TILE	JAN	JANITOR	RCP	REFLECTED CEILING PLAN
DWG	DRAWING	JB	JUNCTION BOX	RD	ROOF DRAIN
DWGS	DRAWINGS	JT	JOINT	REF	REFRIGERATOR
DWR	DRAWER			REINF	REINFORCED
		KIT	KITCHEN	REQD	REQUIRED
(E)	EXISTING	KPL	KICK PLATE	RESIL	RESILIENT
E	EAST	KS	KNEE SPACE	RET	RETURN
EA	EACH			REV	REVISION
ECAB	ELECTRICAL CABINET	LAB	LABORATORY	RH	RIGHT HAND
EG	EDGE GUARD	LAM	LAMINATE	RM	ROOM
EIFS	EXTERIOR INSULATION FINISH SYSTEM	LAV	LAVATORY	RO	ROUGH OPENING
EL	ELEVATION	LB	POUND	ROW	RIGHT OF WAY
ELEC	ELECTRICAL	LF	LINEAR FOOT		
ELEV	ELEVATION	LG	LENGTH	S	SOUTH
EMER	EMERGENCY	LH	LEFT HAND	SA	SUPPLY AIR
ENCL	ENCLOSURE	LIN	LINEAR	SB	SPLASH BLOCK
ENGR	ENGINEER	LKR	LOCKER	SC	SOLID CORE
EO	ELECTRICAL OUTLET	LT	LIGHT	SCD	SEAT COVER DISPENSER
EQL SP	EQUALLY SPACED	LT WT	LIGHT WEIGHT	SCHED	SCHEDULED
EQUIP	EQUIPMENT	LTG	LIGHTING	SCR	SHOWER CURTAIN ROD
EQUIV	EQUIVALENT			SD	SOAP DISPENSER
EXP	EXPANSION			SECT	SECTION
EXPO	EXPOSED			SEP	SEPARATION
EXIST	EXISTING			SF	SQUARE FOOT
EXT	EXTERIOR				

DRAWING SYMBOLS




REVISIONS:

THRHA
 Single Family Dwelling

STATUS:
CONSTRUCTION DOCUMENTS

DRAWN BY: NMG
 CHECKED BY: NMG
 DATE: 3.6.23
 PROJECT #: 222321.10

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SHEET DESCRIPTION:
 Abbreviations & Symbols

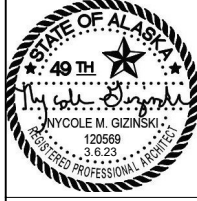G101

SHEET:
 02 of 28

GENERAL NOTES

COMPLY WITH ALL PROVISIONS OF THE INTERNATIONAL CODES AS ADOPTED BY THE CITY & BOROUGH OF JUNEAU-DOUGLAS AND THE STATE OF ALASKA.

- ALL WORK SHALL CONFORM TO ALL APPLICABLE CODES, INCLUDING THE LATEST ADOPTED EDITIONS OF THE IBC, IFC, IMC, IPC, IRC, UFC, UMC, UPC, NEC, AND ADA ACCESSIBILITY GUIDELINES.
- THE ARCHITECTURAL DRAWINGS ARE A PART OF LARGER SET OF DRAWINGS WHICH, WHEN COMPLETE, CONSISTS OF ALL DRAWINGS LISTED BY THE INDEX OF DRAWINGS. THE WORK DESCRIBED BY THE DRAWINGS OF ANY ONE DISCIPLINE MAY BE AFFECTED BY THE WORK DESCRIBED ON DRAWINGS OF ANOTHER DISCIPLINE AND MAY REQUIRE REFERENCE TO THE DRAWINGS OF ANOTHER DISCIPLINE. PARTIAL SETS OF DRAWINGS ARE INCOMPLETE AND SHOULD NOT BE DISTRIBUTED OR UTILIZED BY THE CONTRACTOR. IT IS THE CONTRACTOR'S RESPONSIBILITY TO REVIEW AND COORDINATE THE WORK OF ALL SUBCONTRACTORS, TRADES, AND SUPPLIERS WITH THE REQUIREMENTS OF THE CONTRACT DOCUMENTS BEFORE COMMENCING CONSTRUCTION, AND TO ASSURE THAT ALL PARTIES ARE AWARE OF ALL REQUIREMENTS, REGARDLESS OF WHERE THE REQUIREMENTS OCCUR IN THE CONTRACT DOCUMENTS, WHICH MIGHT AFFECT THE WORK OF THAT PARTY.
- CONTRACTOR SHALL VERIFY ALL SITE CONDITIONS AND BUILDING DIMENSIONS PRIOR TO PROCEEDING WITH THE WORK. ANY VARIATION FROM THE CONDITIONS AND DIMENSIONS SHOWN ON THE DRAWINGS SHALL BE REPORTED TO THE OWNER OR ARCHITECT FOR RESOLUTION PRIOR TO CONSTRUCTION.
- CONTRACTOR-INITIATED CHANGES SHALL BE SUBMITTED IN WRITING TO THE OWNER'S REPRESENTATIVE FOR APPROVAL PRIOR TO FABRICATION OR CONSTRUCTION. CHANGES SHOWN ON SHOP DRAWINGS ONLY WILL NOT SATISFY THIS REQUIREMENT.
- WRITTEN DIMENSIONS TAKE PRECEDENCE OVER SCALED DIMENSIONS. DIMENSIONS ARE TO CENTERLINE OF COLUMNS OR TO FACE OF FRAMING, UNLESS OTHERWISE NOTED. DIMENSIONS NOTED AS "CLEAR" ARE TO FACE OF FINISH MATERIALS.
- REFER TO THE STRUCTURAL, MECHANICAL, ELECTRICAL, CIVIL, LANDSCAPE AND PLUMBING DRAWINGS FOR THE DETAILED DESIGN OF STRUCTURAL, MECHANICAL, ELECTRICAL, CIVIL, LANDSCAPE AND PLUMBING SYSTEMS, OF WHICH PORTIONS MAY BE SHOWN ON THE ARCHITECTURAL DRAWINGS.
- FINISH FLOOR ELEVATIONS ARE TO TOP OF CONCRETE FLOOR SLAB OR WOOD SUB-FLOOR, UNLESS OTHERWISE NOTED.
- CEILING HEIGHT DIMENSIONS ARE TO FINISHED SURFACES, UNLESS OTHERWISE NOTED.
- PROVIDE FIRE BLOCKING, DRAFT STOPS, AND FIRE STOPS PER IBC SECTION 717.
- PROVIDE AN 2A 10BC FIRE EXTINGUISHER PER PLANS.
- WINDOWS IN OCCUPIED, HEATED AREAS OF BUILDING TO BE DOUBLE PANE, INSULATED GLAZING.
- SAFETY GLAZING: WIRED, TEMPERED, AND LAMINATED SAFETY GLASS MUST MEET UBC STANDARDS. GLAZING IN OR ADJACENT TO DOORS (12") AND GLAZING LESS THAN 18" ABOVE FLOOR, AND OTHER HAZARDOUS LOCATIONS PER UBC SEC. 2406.
- MINIMUM INSULATION REQUIREMENTS IN OCCUPIED, HEATED AREAS OF BUILDING, UON:


ROOF/CEILING	R49
EXT. WALLS	R21
FLOORS & SOFFITS	R30
HOT WATER PIPES	1/2"

ALLOW 2" MIN. AIR SPACE OVER INSULATION WHEN BATTS ARE USED BETWEEN RAFTERS & TRUSSES. SEAL ALL TEARS AND JOINTS WITH TAPE. ALL ROOF INSULATION APPLIED DIRECTLY TO EXTERIOR FRAMING MEMBERS SHALL BE PROVIDED WITH VAPOR BARRIER ON HEATED SIDE. ALL OPENINGS (DOORS, WINDOWS, ETC.) SHALL BE CAULKED, SEALED, OR WEATHERSTRIPPED.


SCOPE OF WORK

Construction of a new 2-Story, 1732 SF single family with attached garage.

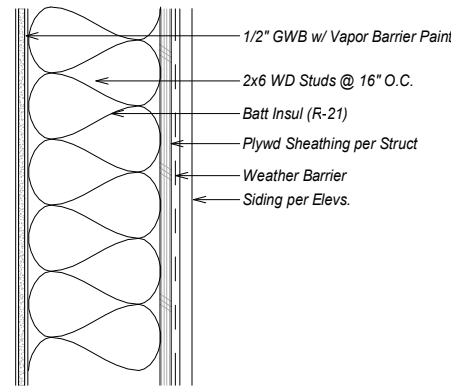
WALL TYPES




1 Typ. Exterior Wall

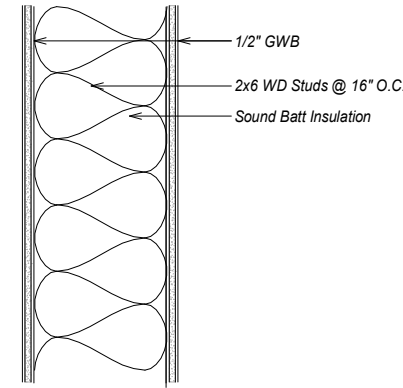


2 Typ. Interior Sound Wall (2x6)

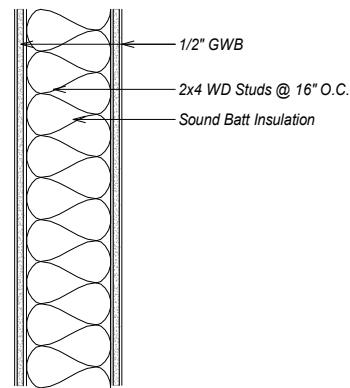

3 Typ. Interior Sound Wall (2x4)

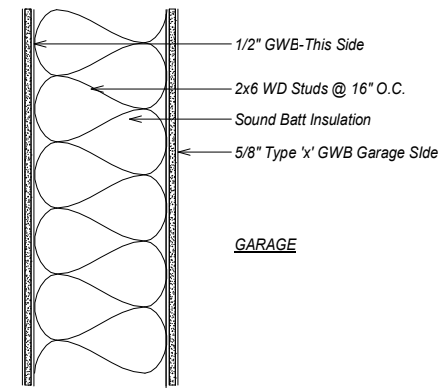

4 Typ. Rated Interior Sound Wall (2x6)

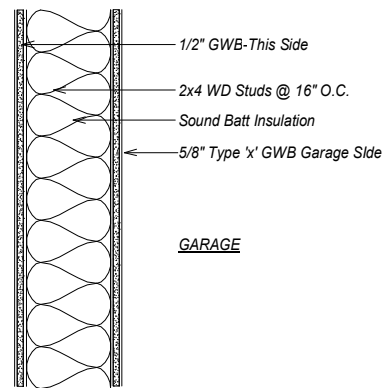

5 Typ. Interior Rated Sound Wall (2x4)


REVISIONS:

THRHA
Single Family Dwelling

STATUS:
CONSTRUCTION DOCUMENTS

DRAWN BY: NMG
CHECKED BY: NMG
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PROJECT #: 222321.10

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SHEET DESCRIPTION:
Notes & Wall Types

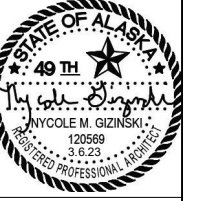A001

SHEET:
18 of 28

Door Schedule

Type Mark	Width	Height	Thickness	Door Type	Door Material	Frame Material	Operation	Fire Rating	Hardware	Description
1	3'-0"	6'-8"	0'-1 3/4"	B	WD/SC	Wood	LH		HDW-1	Insulated Door w/ Relite
2	2'-6"	6'-8"	0'-1 3/8"	D	WD/SC	Wood	RH		HDW-3	
3	3'-0"	6'-8"	0'-1 3/4"	D	WD/SC	Wood	LHR	20 Min	HDW-1	
4	9'-0"	8'-0"	0'-2"	F	Alum	Alum				Insulated Overhead Door w/ Relites
5	3'-0"	6'-8"	0'-1 3/4"	D	WD/SC	Wood	RH		HDW-2	
6	3'-0"	6'-8"	0'-1 3/8"	D	WD/SC	Wood	LH		HDW-2	
7	2'-6"	6'-8"	0'-1 3/8"	D	WD/SC	Wood	LH		HDW-2	
9	5'-0"	6'-8"	0'-1 3/4"	A	Vinyl	Vinyl	Sliding			Insulated Sliding Patio Door w/ Transom
10	5'-0"	6'-8"	0'-1 3/4"	E	Wood	Wood			HDW-4	Bi-Fold Door Pair
11	2'-6"	6'-8"	0'-1 3/8"	D	WD/SC	Wood	LHR		HDW-2	

DOOR HARDWARE

- A. General:
- Furnish finish hardware with suitable stainless steel fasteners for a complete installation.
 - Products complete and of equal quality and finish.
- B. Locks, Latches, & Handles: ANSI A156.2-89 or A156.13-94, keying on schedule; furnish with lever handles, two keys for each lock and two master keys.

TYPE	ITEM	Manuf.	Model #	Remarks
L1	Entrance Lock	Kwikset	690BL 15 CP K6	Entrance Lock with Deadbolt
L2	Privacy Lock	Kwikset	300BL 15 6AL RC	
L3	Passage	Kwikset	200BL 15 6AL RC	
L4	Bi-Fold Door Handle	Prime-Line	N 7372	

- C. Stops: ANSI A156.16-89.

TYPE	ITEM	Manuf.	Model #	Remarks
S1	Door Stops	Everbilt	15586	


- D. Thresholds: ANSI A156.21 & ANSI A117.1.2013

TYPE	ITEM	Manuf.	Model #	Remarks
T1	Saddle	Pemco	TBD	


- E. HARDWARE SCHEDULE

ITEM	TYPE
HDW-1 Single Locked Entrance Door	
1 Lock	L1
1 Threshold	T1
1 Set Weatherstrip	W1
1 Door Stop	S1
HDW-2 Bathroom/Bedroom Door with Privacy Lock	
1 Privacy Lock	L2
1 Door Stop	S1
HDW-3 Passage Door	
1 Latch	L3
1 Door Stop	S1
HDW-4 Bi-fold Door	
1 Knob	L6

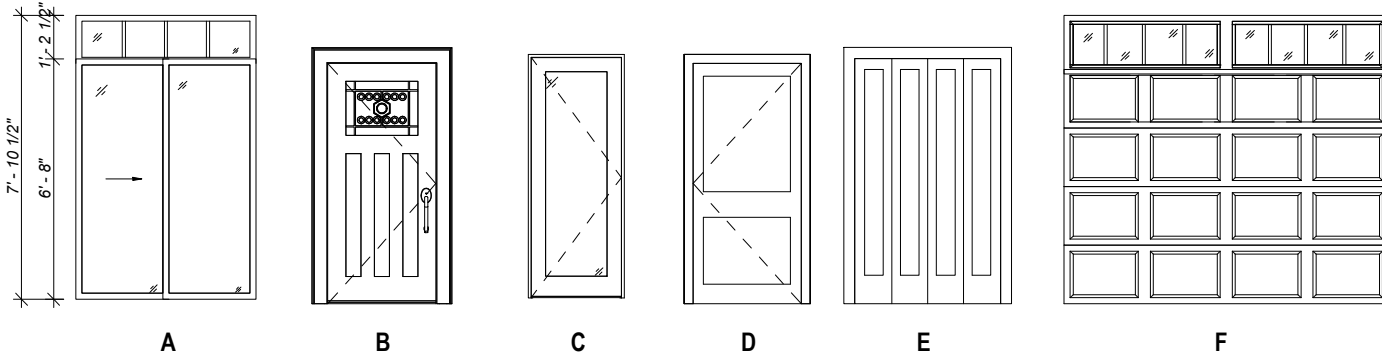
DOOR TYPES



WINDOW TYPES

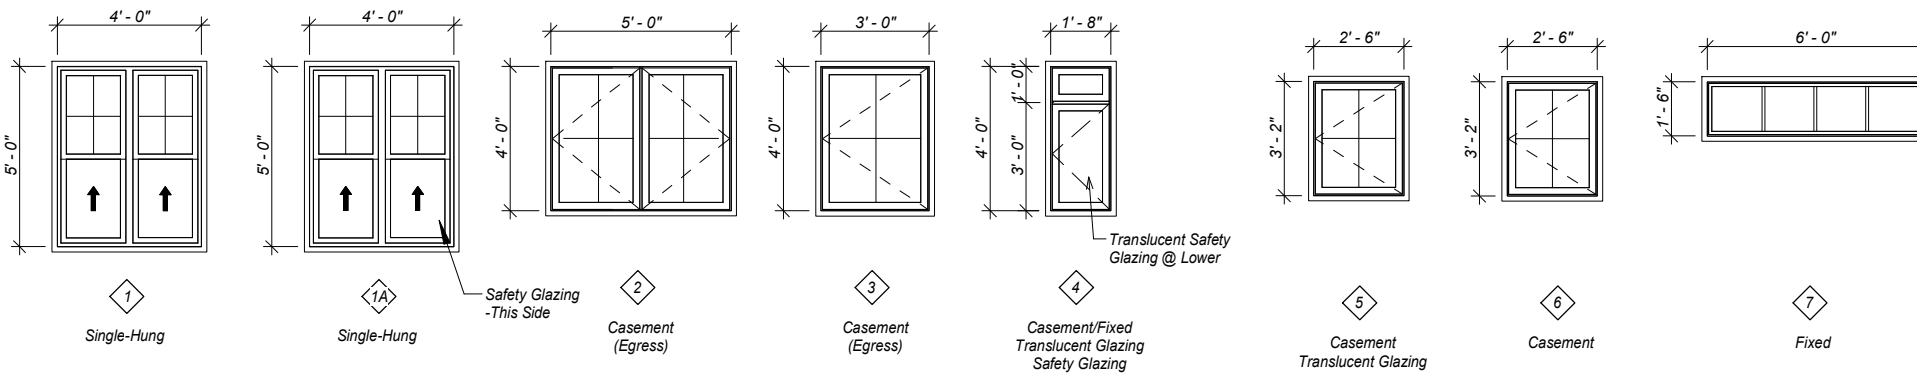

WINDOW, DOOR, BASE TRIM

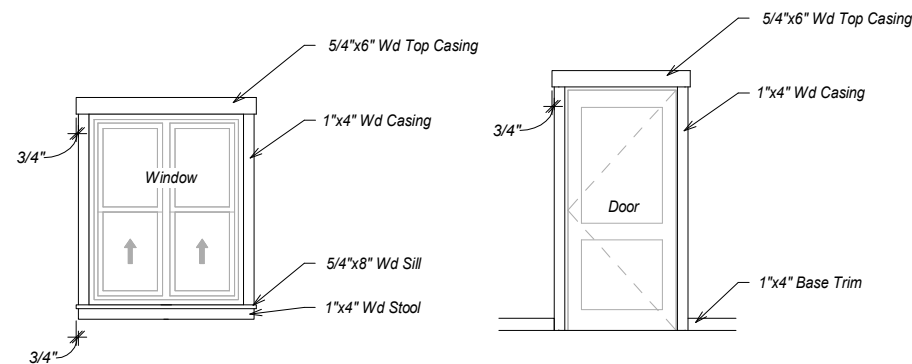

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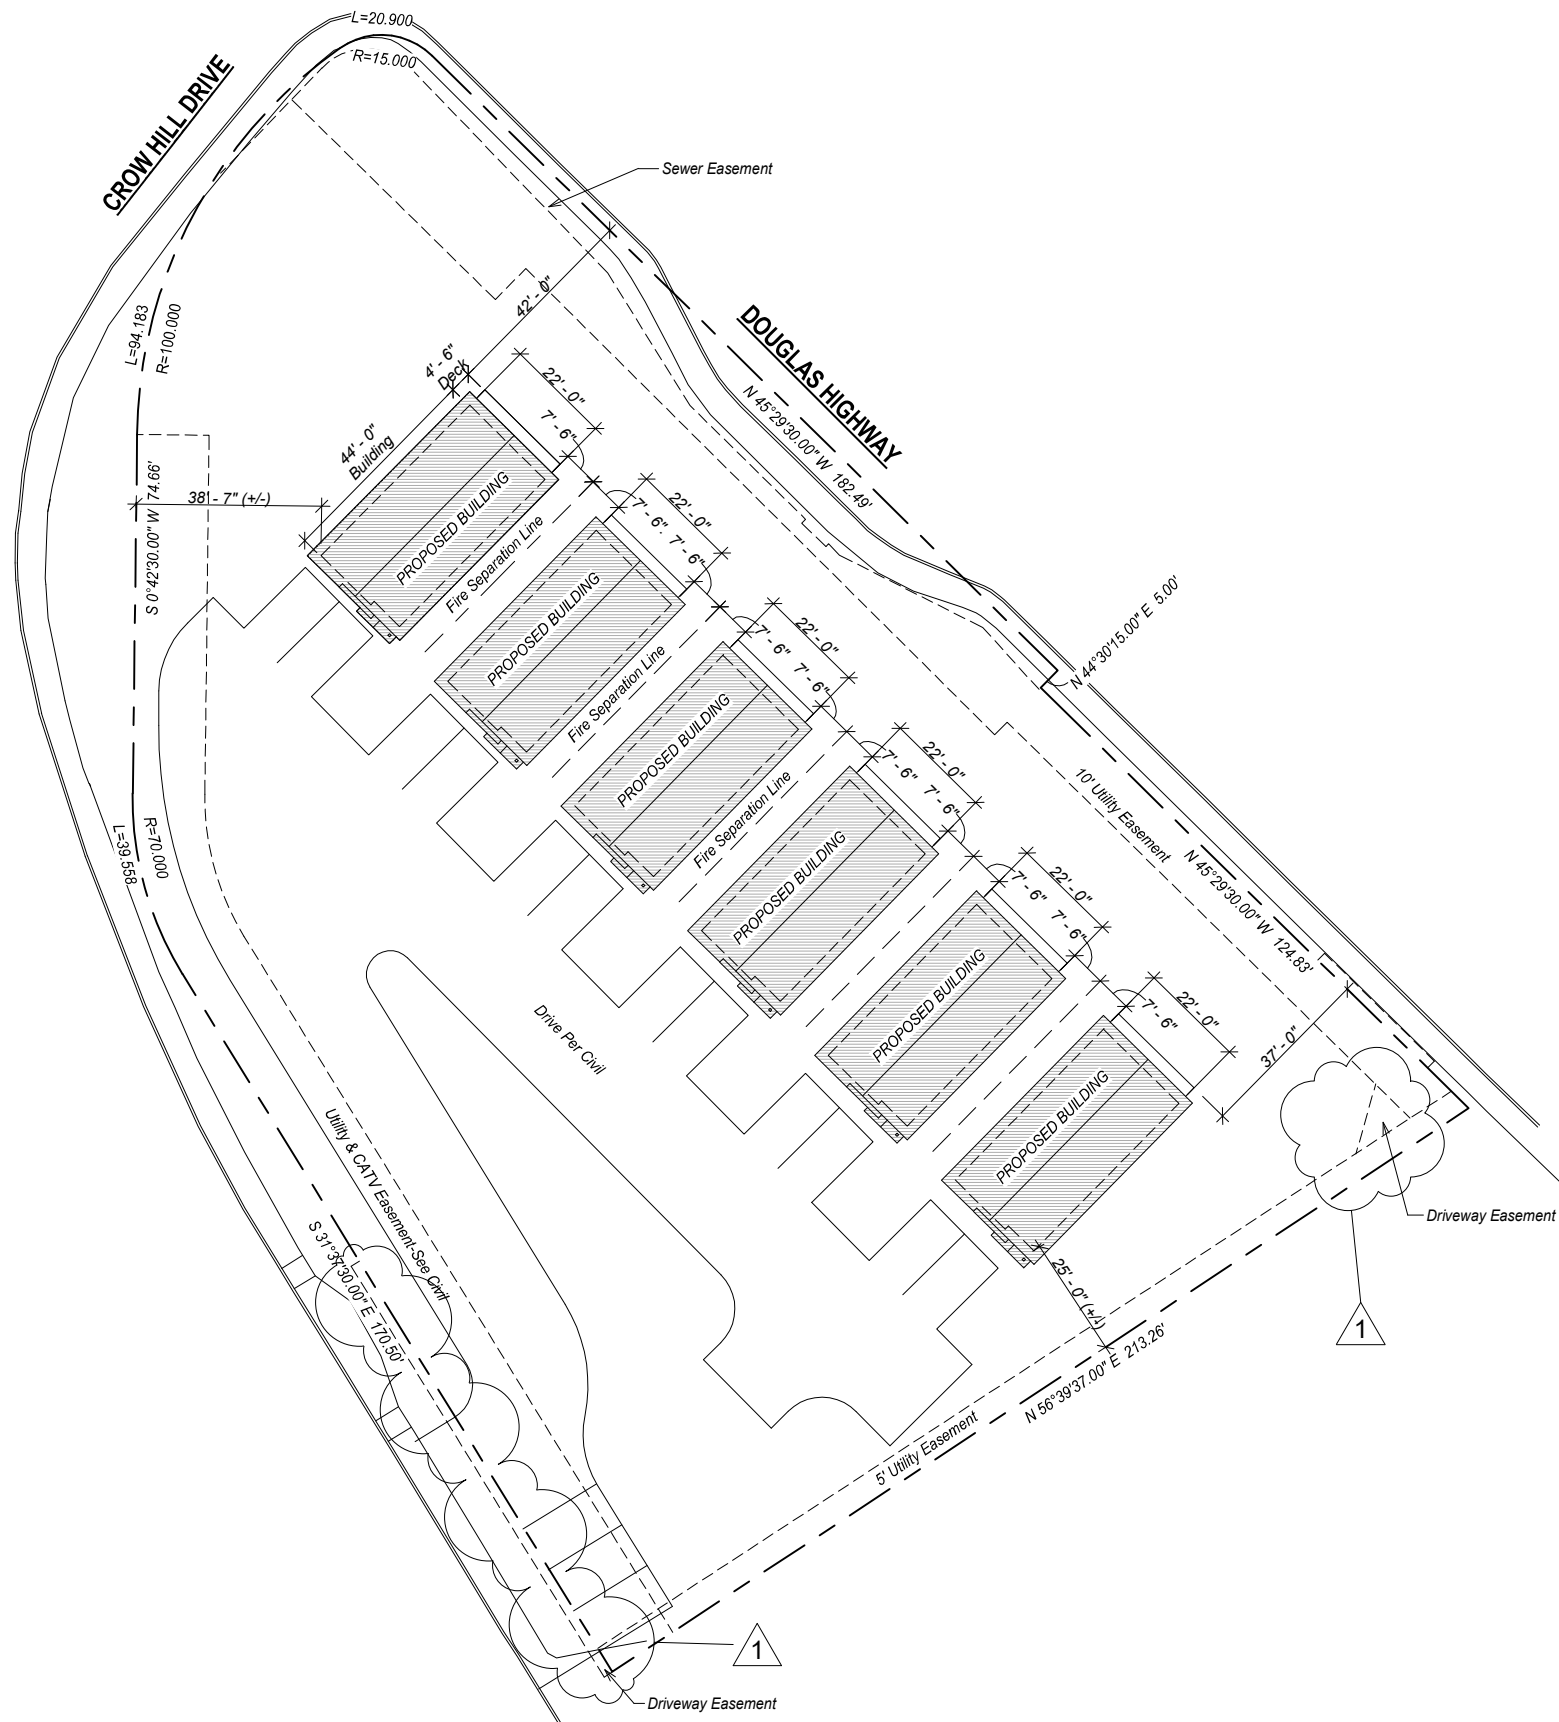
SHEET DESCRIPTION:

Schedules

A002

SHEET:

19 of 28



1 Site Plan
1" = 40'-0"

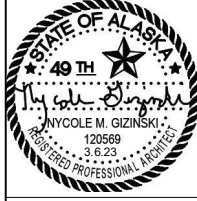
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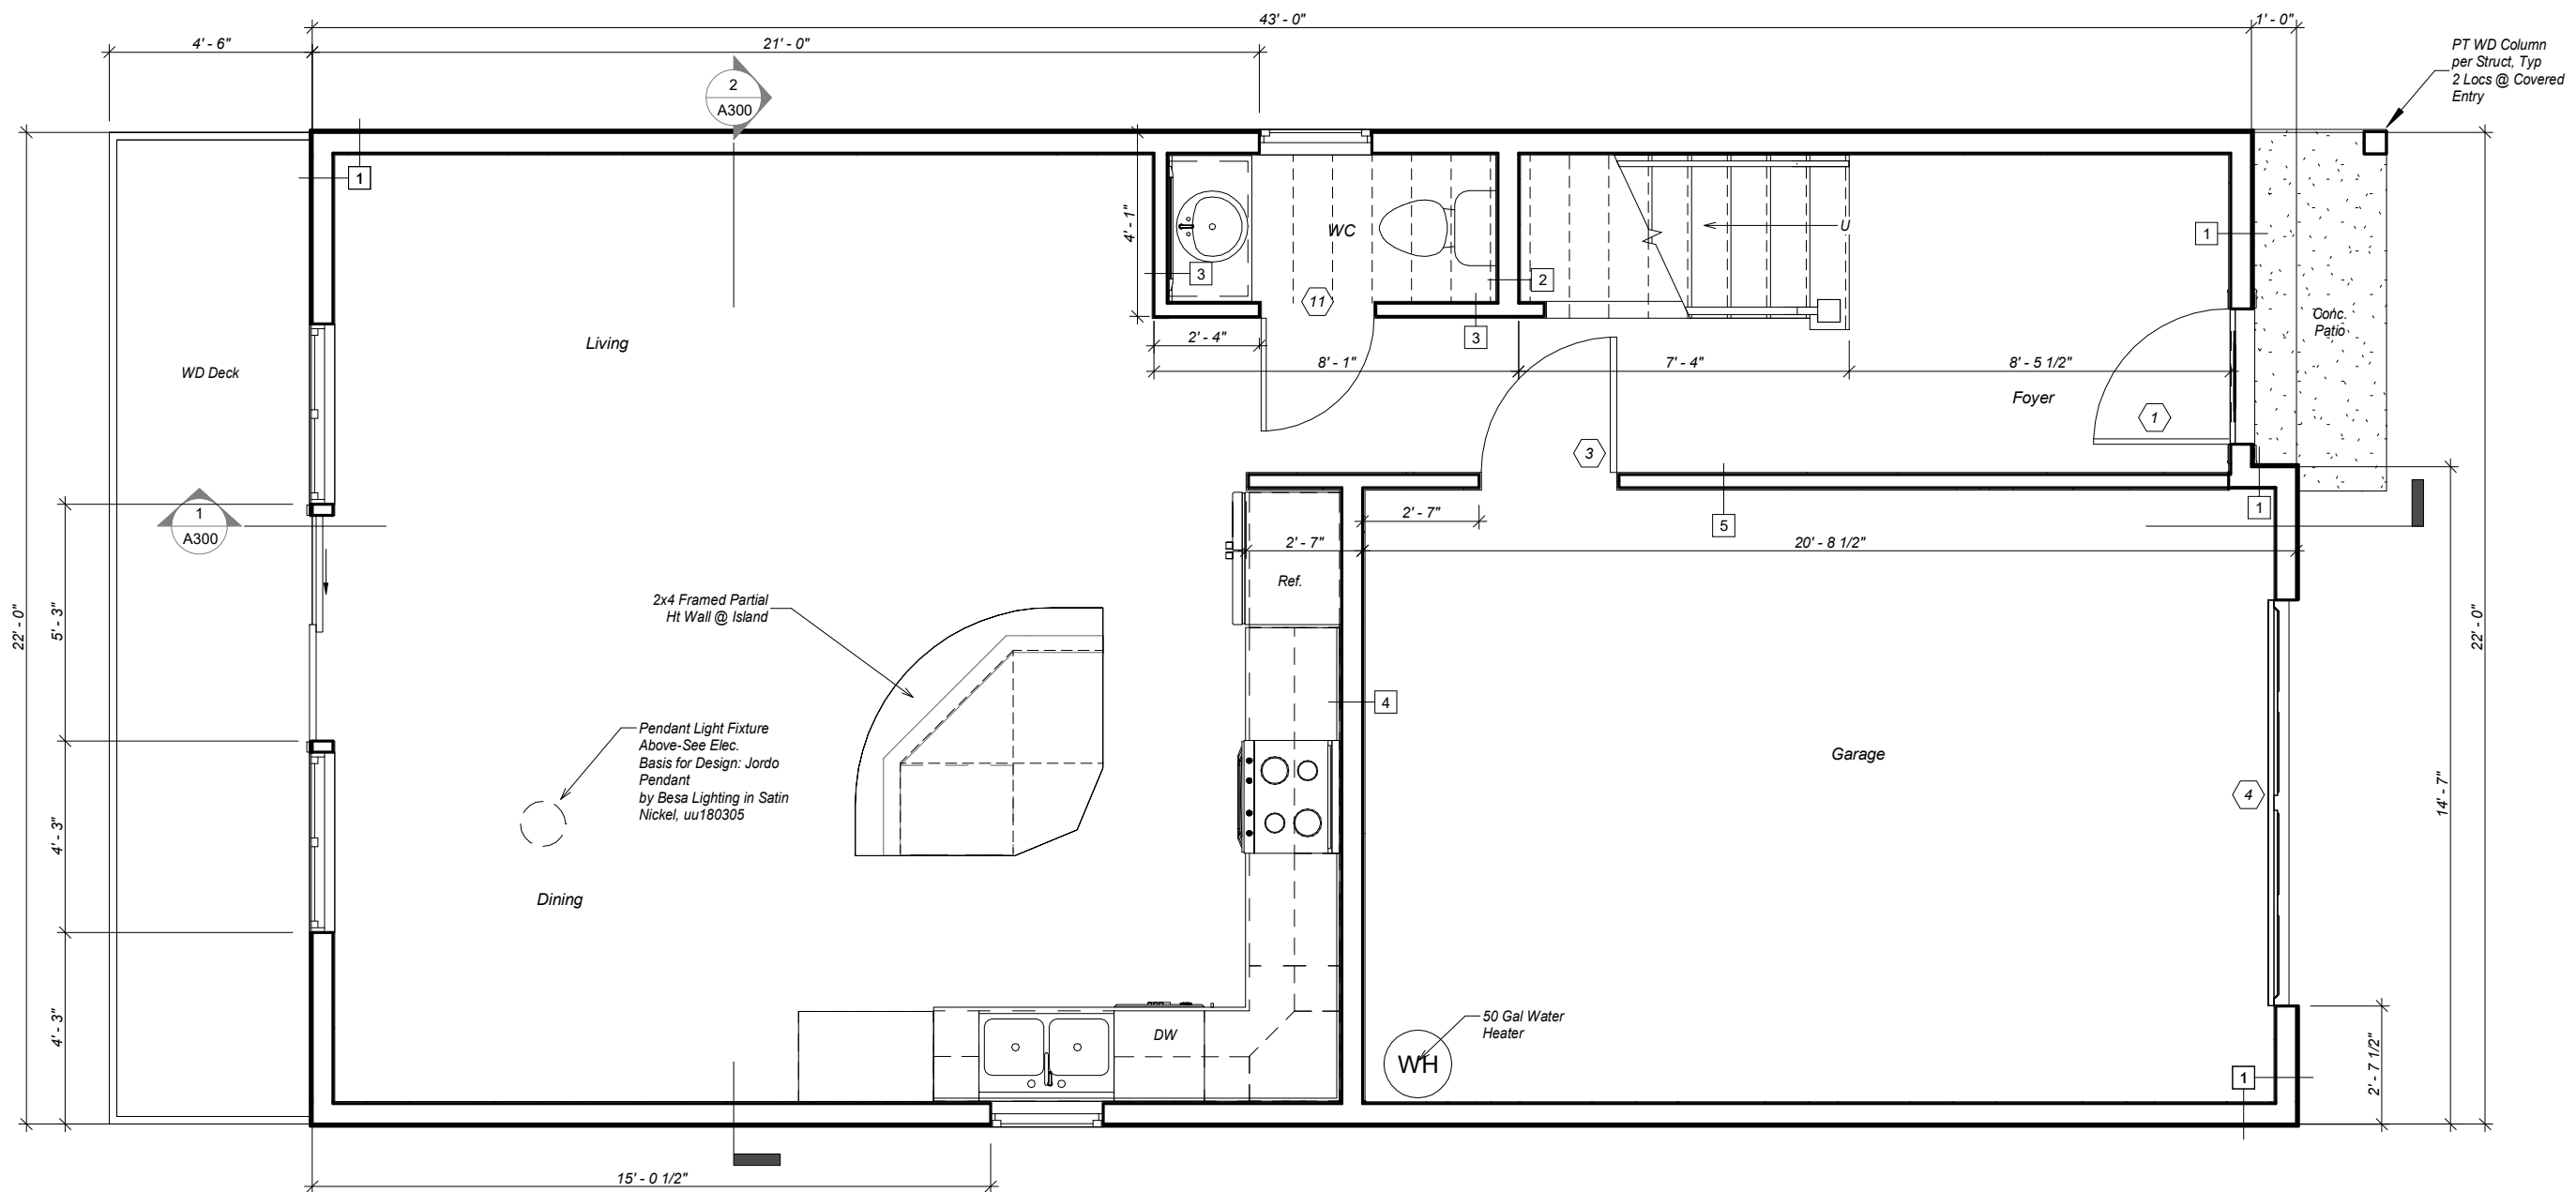
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SHEET DESCRIPTION:
Architectural Site Plan

A100



1 Main Level
1/4" = 1'-0"



REVISIONS:

REV #5 3.17.22

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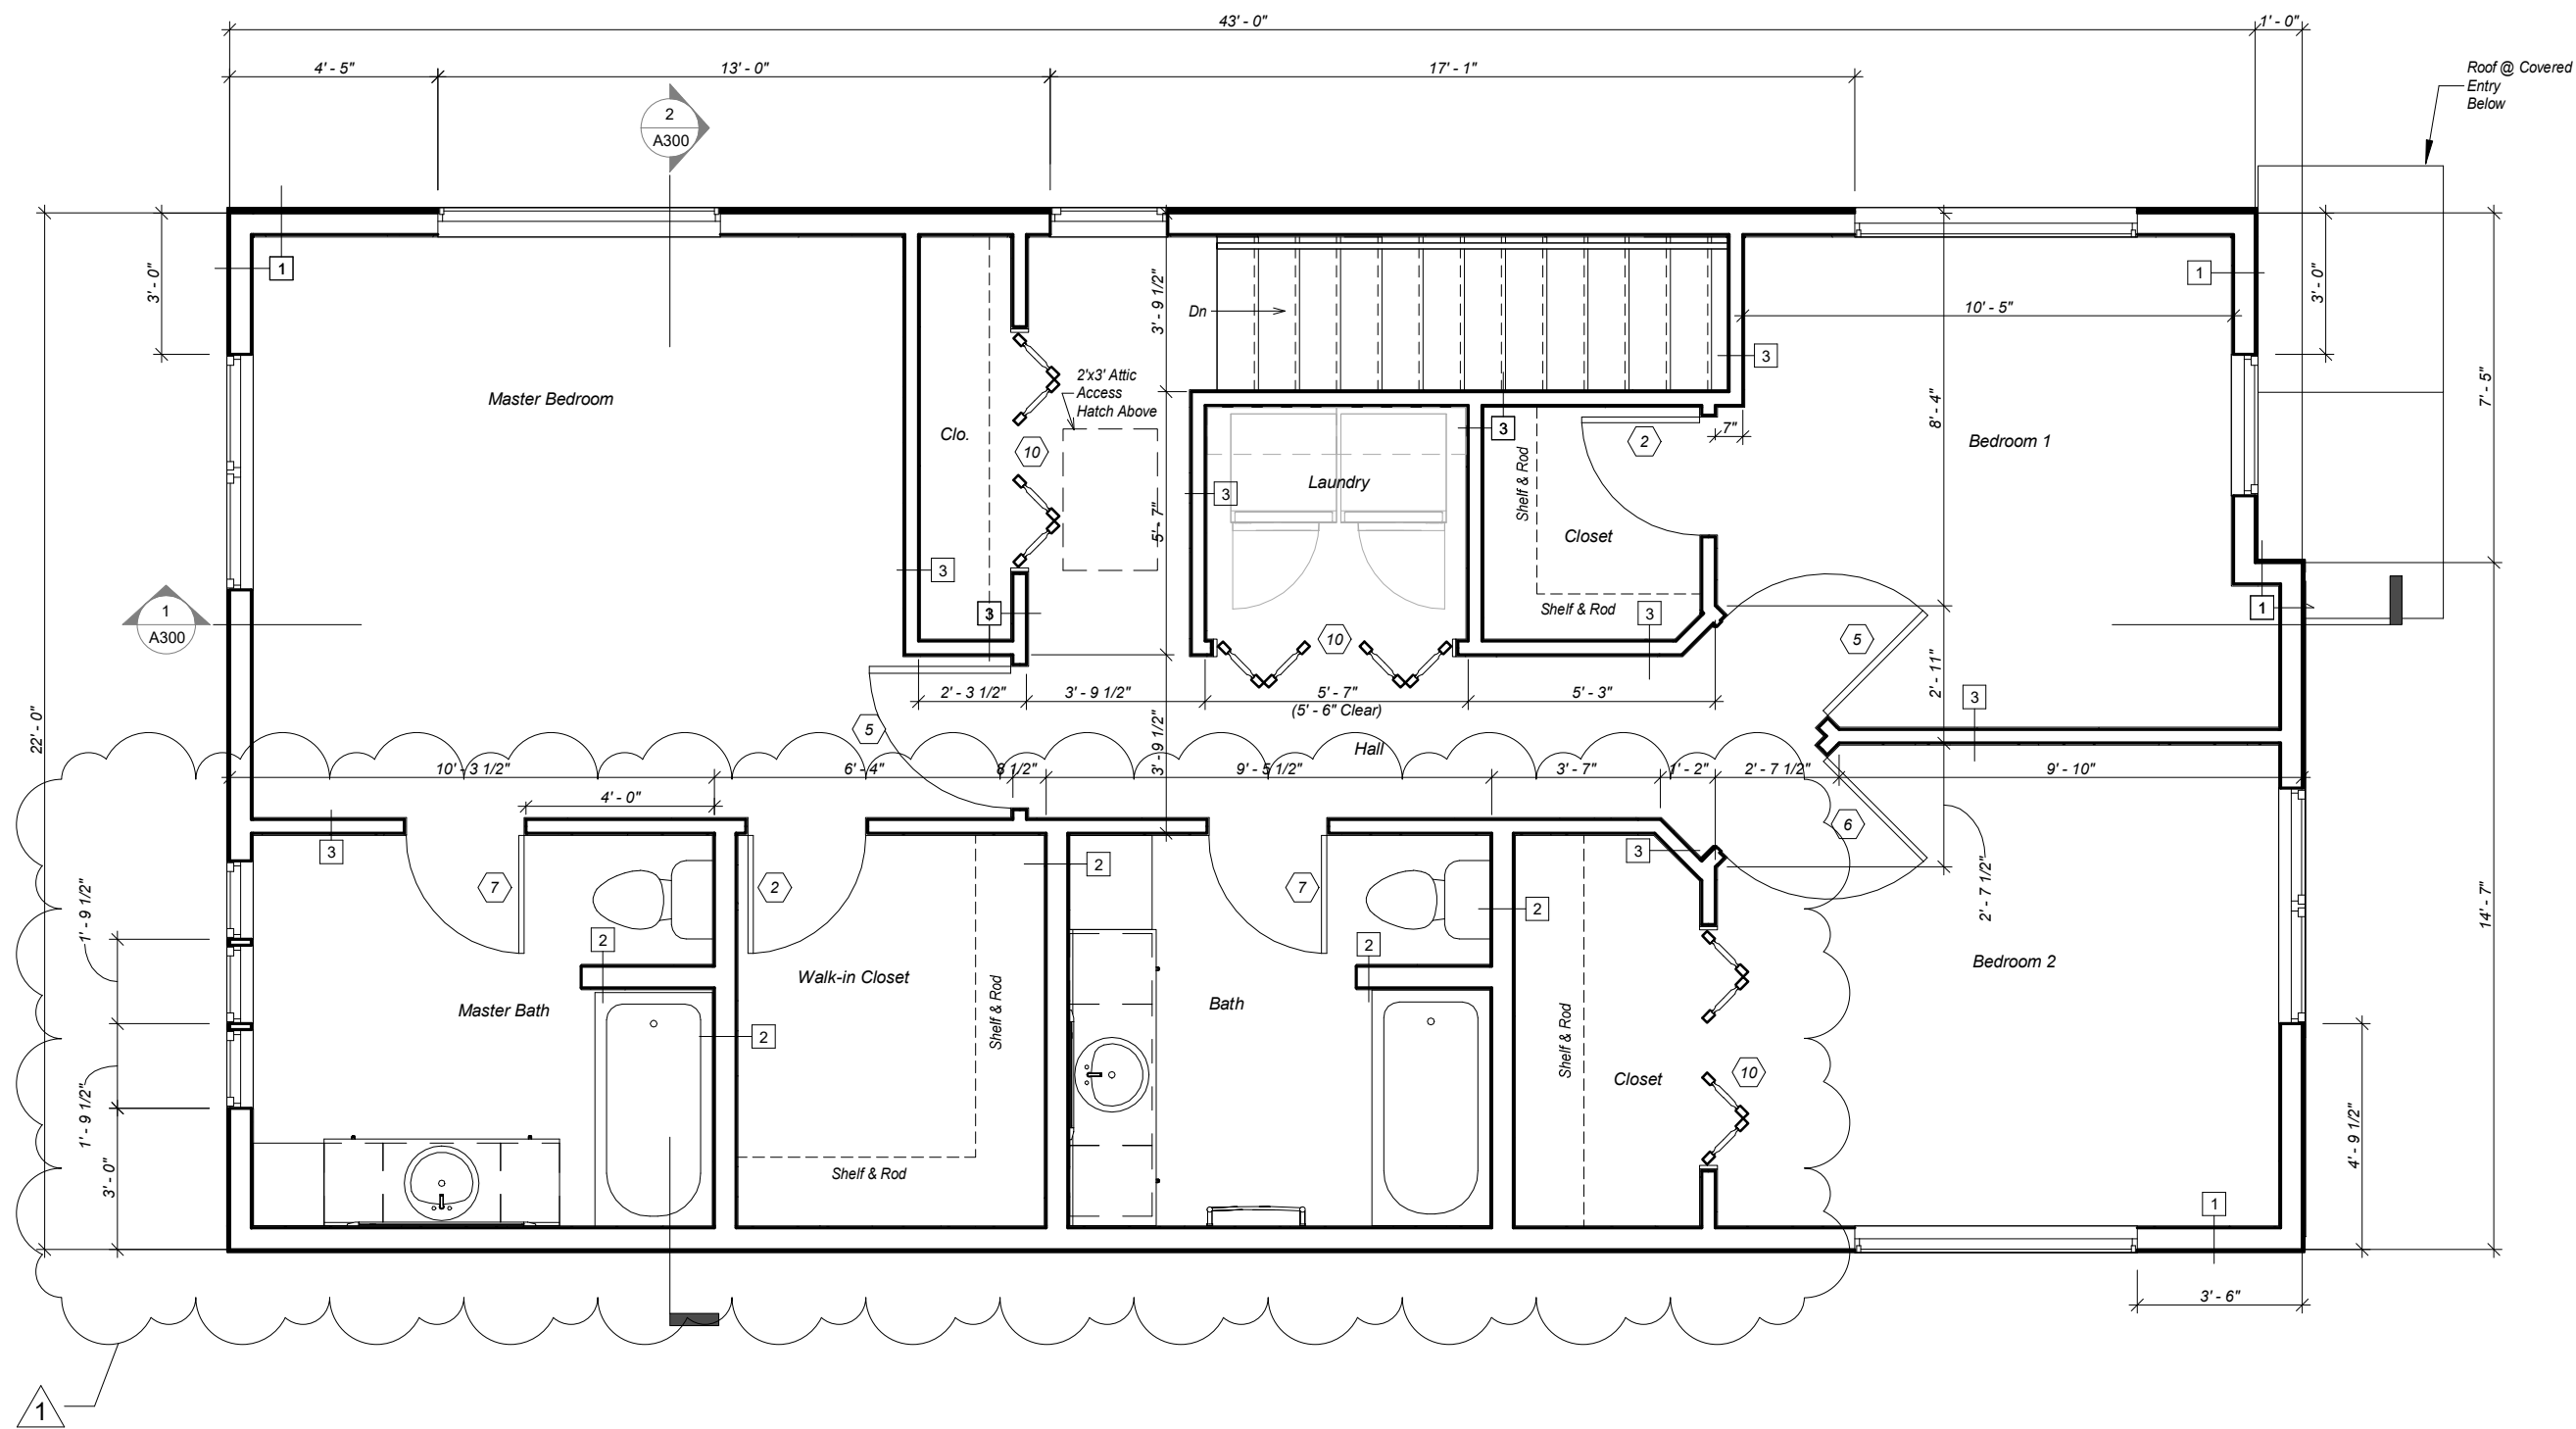
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SHEET DESCRIPTION:
Main Floor Plan

A200

SHEET:
21 of 28



1 Upper Level
 1/4" = 1'-0"



REVISIONS:
REV #1: 6.8.24

THRHA
 Single Family Dwelling


STATUS:
CONSTRUCTION DOCUMENTS

DRAWN BY: NMG
 CHECKED BY: NMG
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SHEET DESCRIPTION: Upper Floor Plan
A201
SHEET: 22 of 28



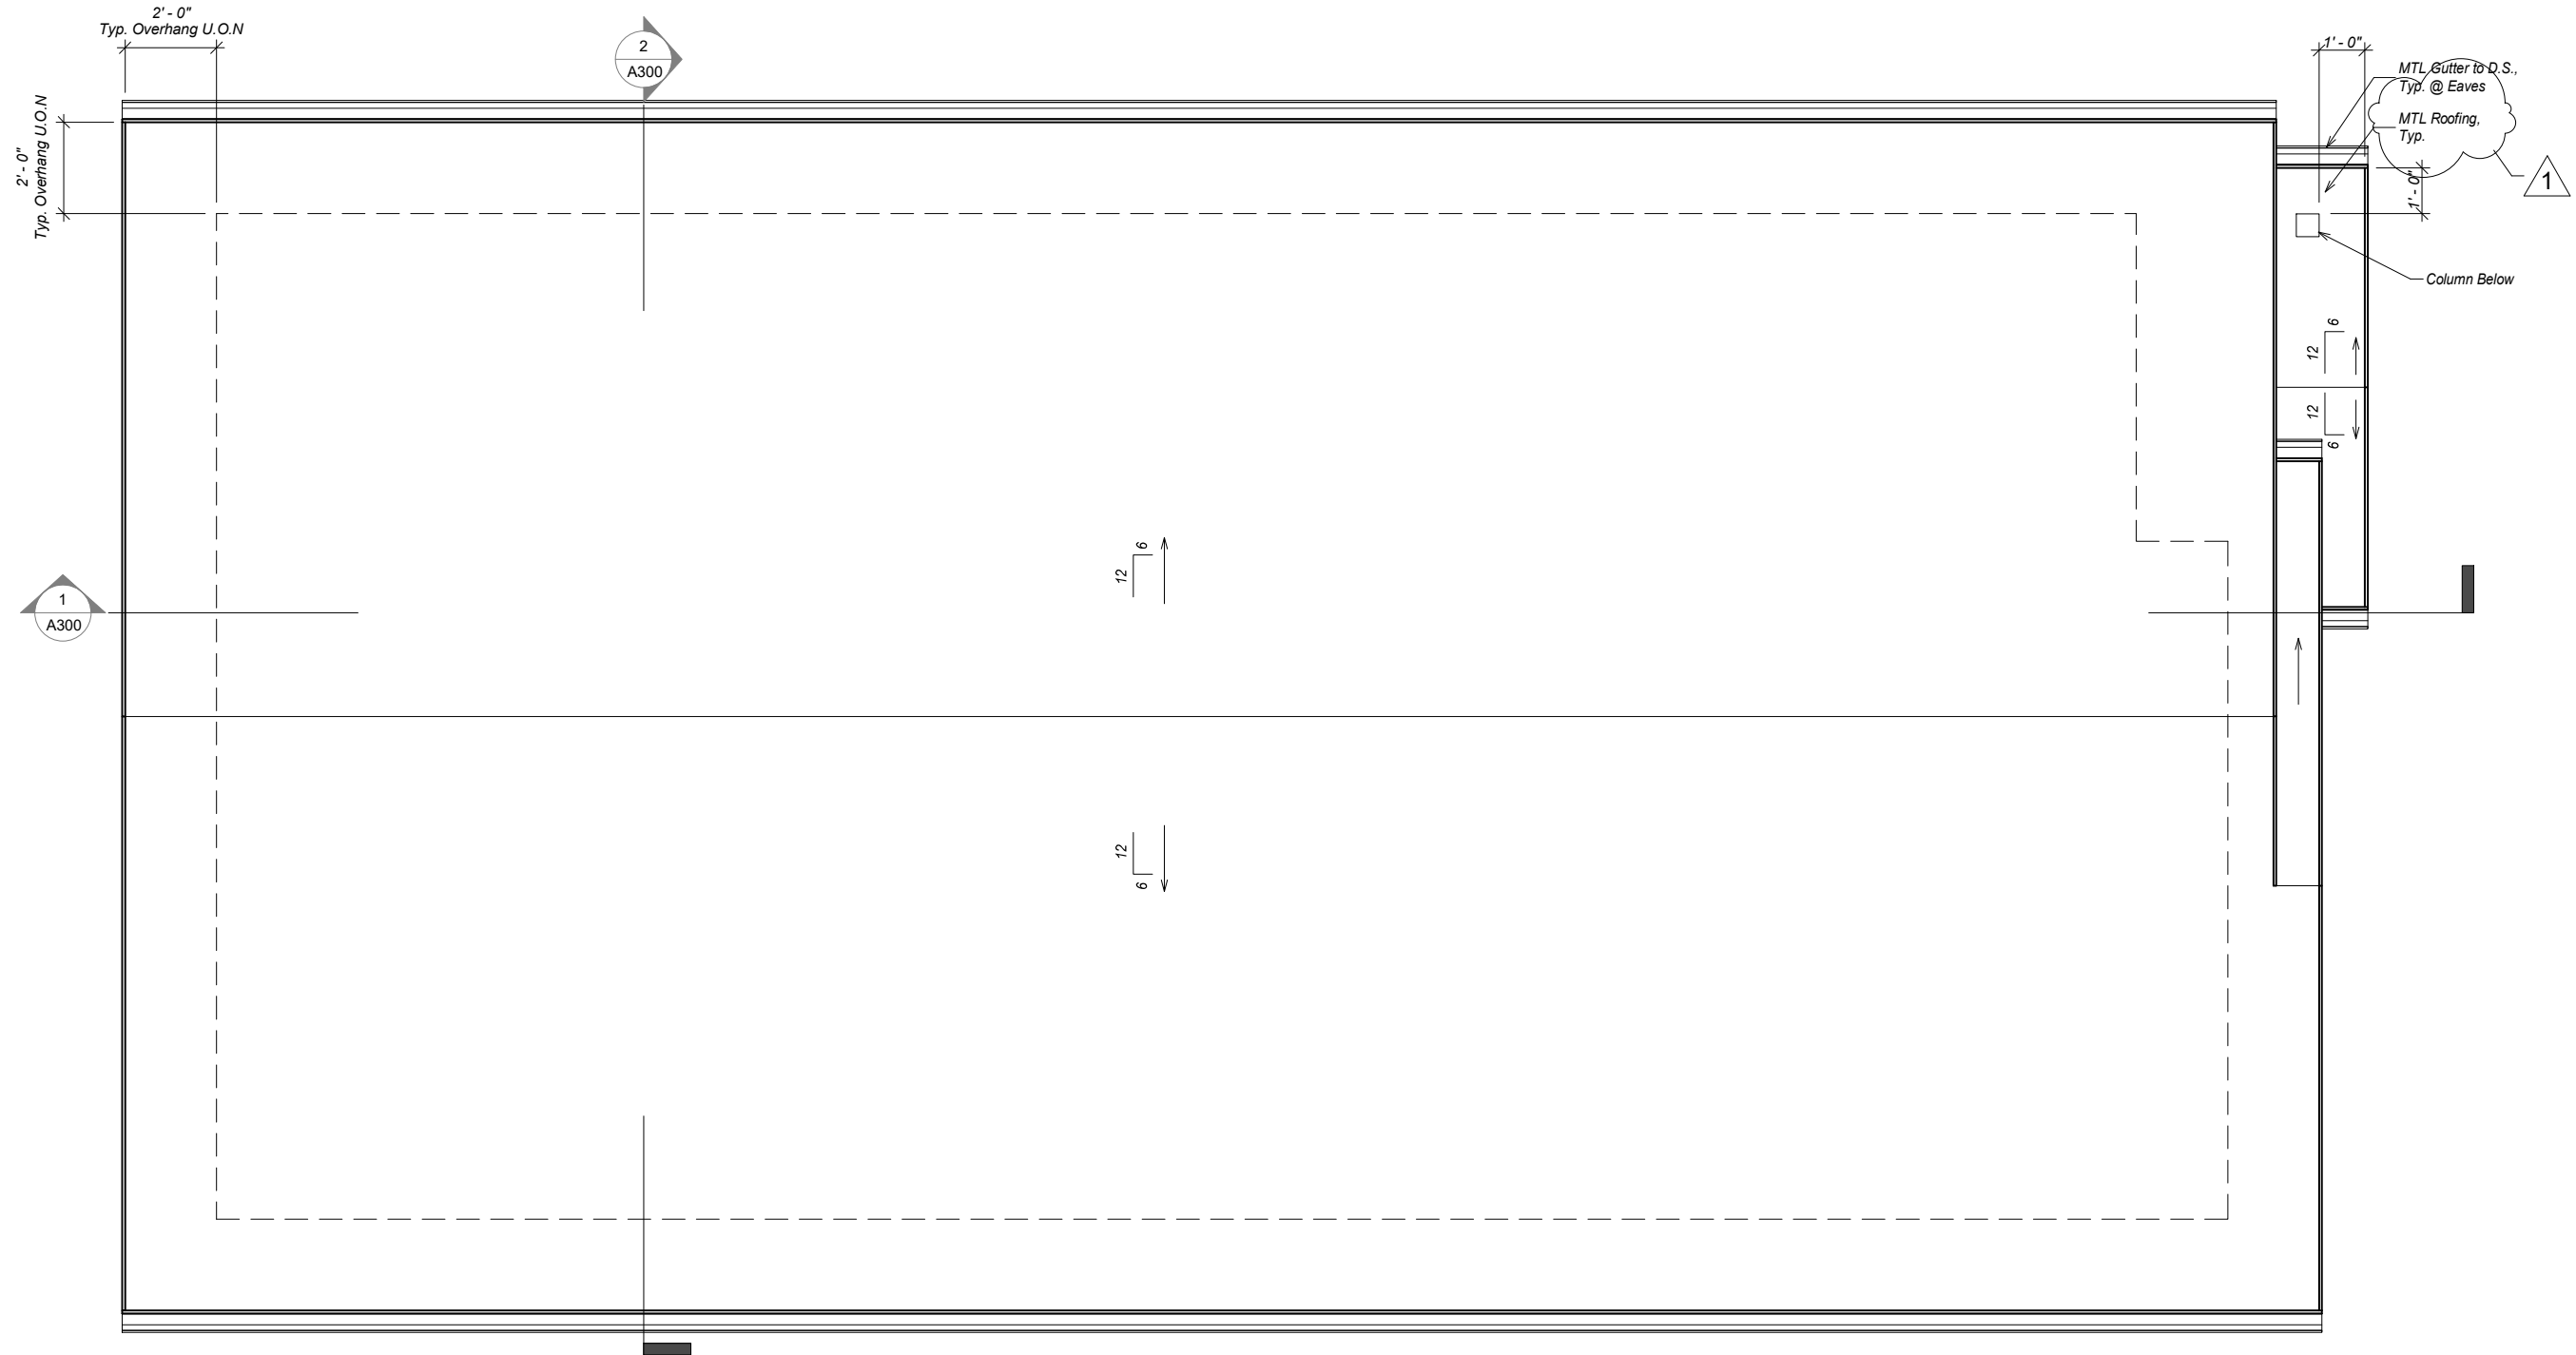1 Roof Plan
1/4" = 1'-0"



MTL ROOFING MATERIAL BASIS FOR DESIGN:
MANUFACTURER: SKYLINE
COLOR: "SLATE GREY"

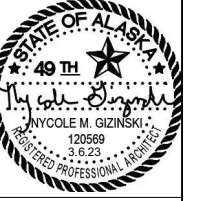
REVISIONS:
REV #1: 5.8.24

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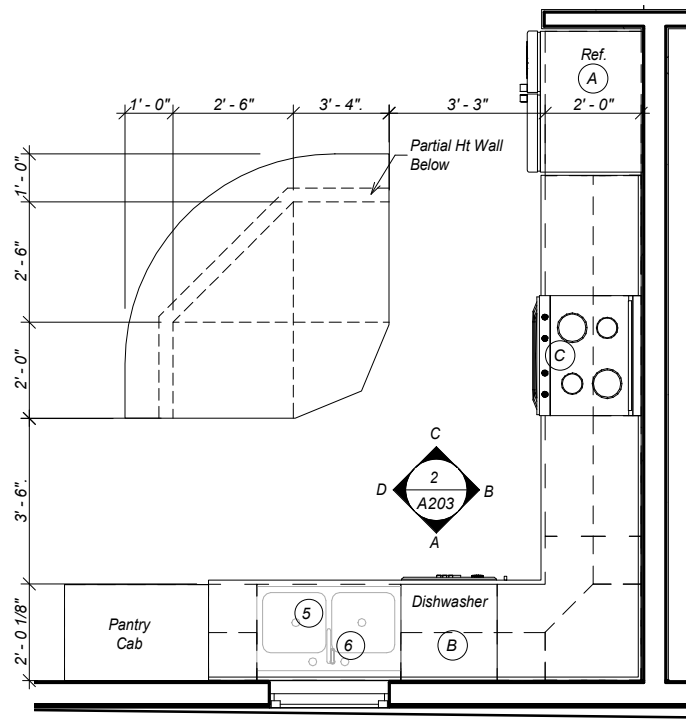
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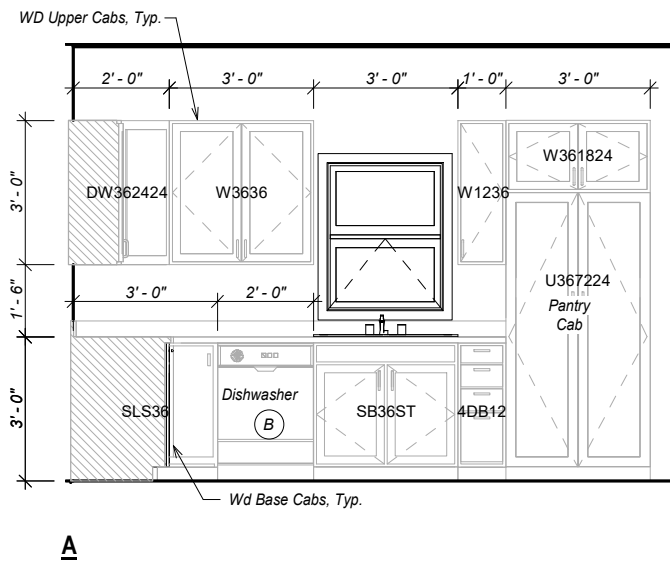
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Roof Plan

A202

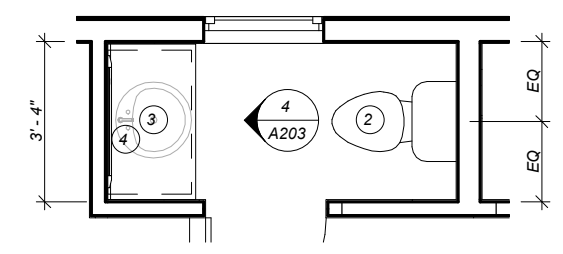
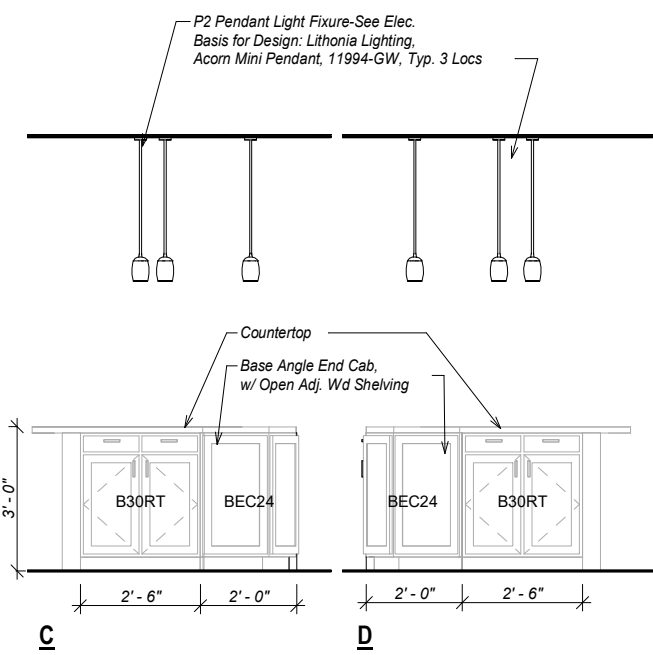
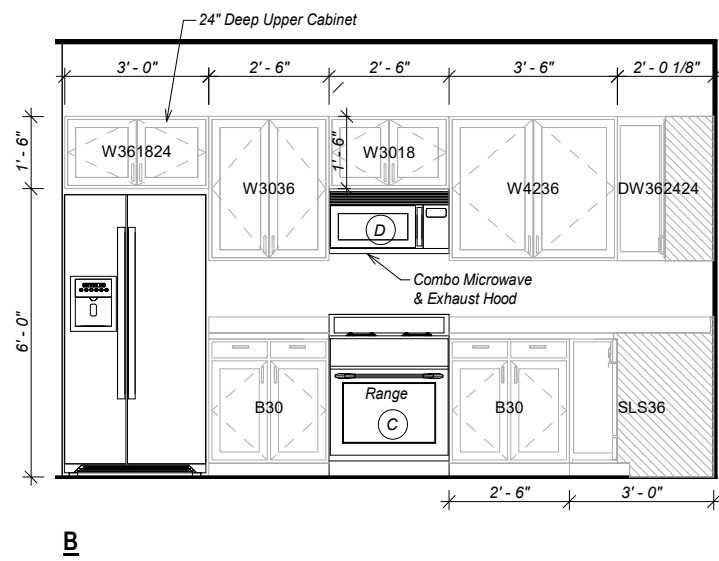
SHEET:
23 of 28




1 Kitchen Plan
 1/4" = 1'-0"



2 Interior Elevations - Kitchen
 1/4" = 1'-0"




3 WC Plan
 1/4" = 1'-0"

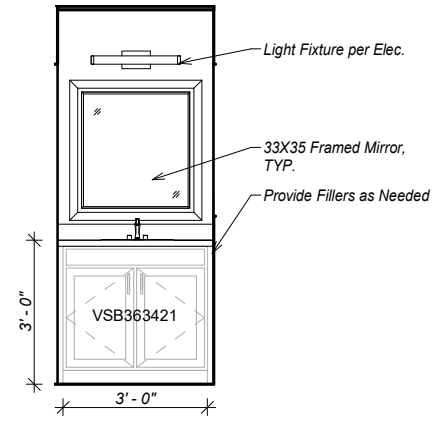


4 Interior Elevation - WC
 1/4" = 1'-0"

Plumbing Fixture Schedule				
Type Mark	Description	Manufacturer	Model	Remarks
1	Tub/Shower Unit	Best Bath Systems	4BTS6030A17.VS	Include Delta Tub/Shower Valve Package & Best Bath Shower Curtain & Rod
2	Toilet	Kohler	K-78276	
3	Sink, Undermount	Kohler	K-20000	
4	Vanity Faucet	Delta	559HA-SS-DST	
5	Sink, Undermount	Kohler	K-75791-1	
6	Faucet	Delta	9178-SP-DST	
7	Heated Towel Bar	Anzzi	TW-AZ0180BN	

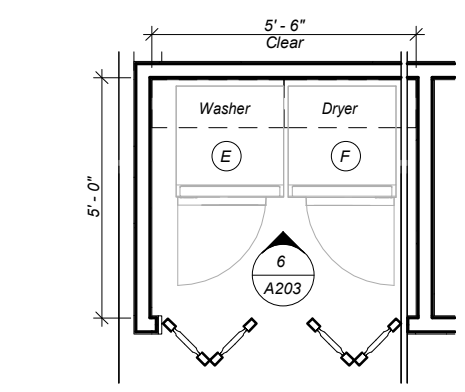

5 Laundry Plan
 1/4" = 1'-0"

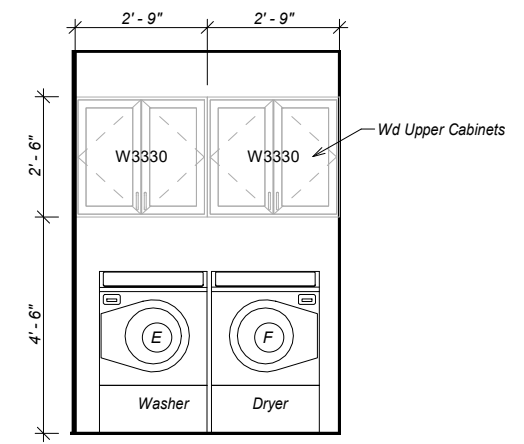

6 Interior Elevation - Laundry
 1/4" = 1'-0"

Appliance Schedule			
Type Mark	Description	Manufacturer	Model
A	Refrigerator	GE	GSS25GSHSS
B	Dishwasher	GE	GDF510PSRSS
C	30" Range, Electric	GE	JBS360RMSS
D	Combo Microwave/Range Hood	GE	PSA9120SFSS
E	Washer	GE	GFW550SPNDG
F	Dryer	GE	GFD55ESPNDG

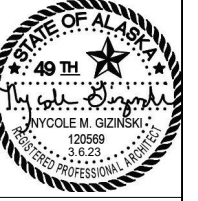
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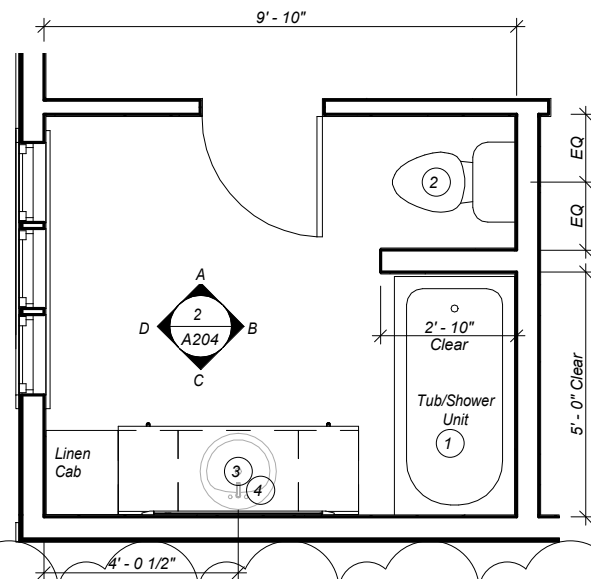
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SHEET DESCRIPTION:
 Enlarged Plans

A203





SHEET:
 24 of 28




1 Master Bath Plan
1/4" = 1'-0"

Plumbing Fixture Schedule					
Type Mark	Description	Manufacturer	Model	Remarks	
1	Tub/Shower Unit	Best Bath Systems	4BTS6030A17.VS	Include Delta Tub/Shower Valve Package & Best Bath Shower Curtain & Rod	
2	Toilet	Kohler	K-78276		
3	Sink, Undermount	Kohler	K-20000		
4	Vanity Faucet	Delta	559HA-SS-DST		
5	Sink, Undermount	Kohler	K-75791-1		
6	Faucet	Delta	9178-SP-DST		
7	Heated Towel Bar	Anzzi	TW-AZ0180BN		




Appliance Schedule			
Type Mark	Description	Manufacturer	Model
A	Refrigerator	GE	GSS25GSHSS
B	Dishwasher	GE	GDF510PSRSS
C	30" Range, Electric	GE	JBS360RMSS
D	Combo Microwave/Range Hood	GE	PSA9120SFSS
E	Washer	GE	GFW550SPNDG
F	Dryer	GE	GFD55ESPNDG

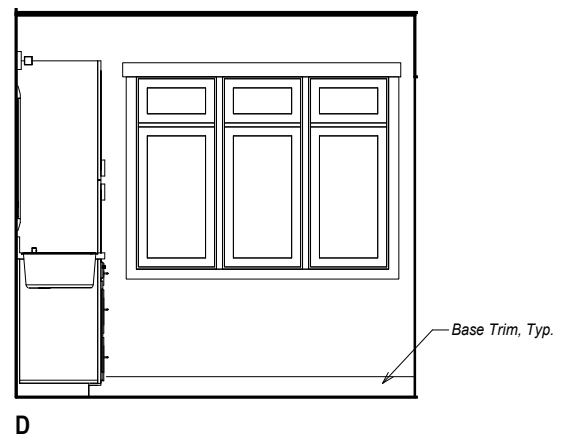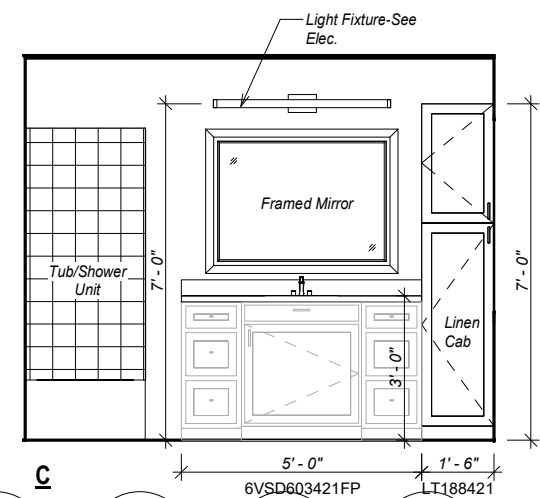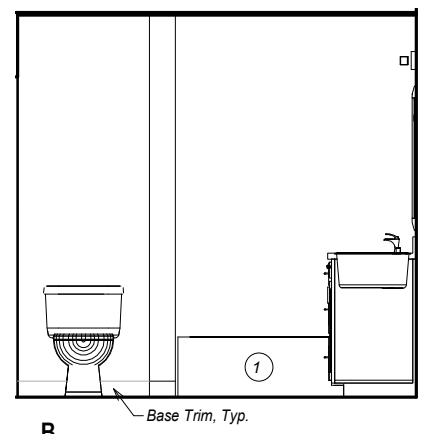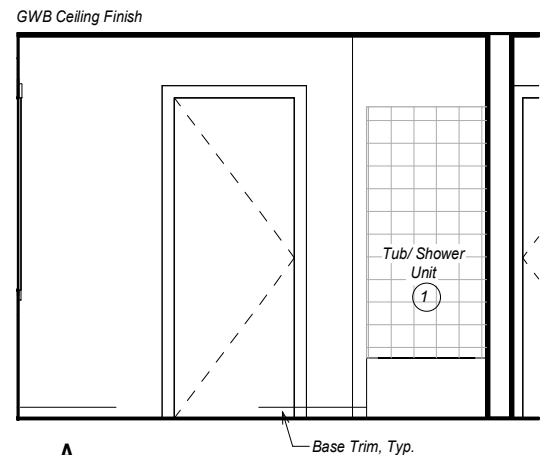

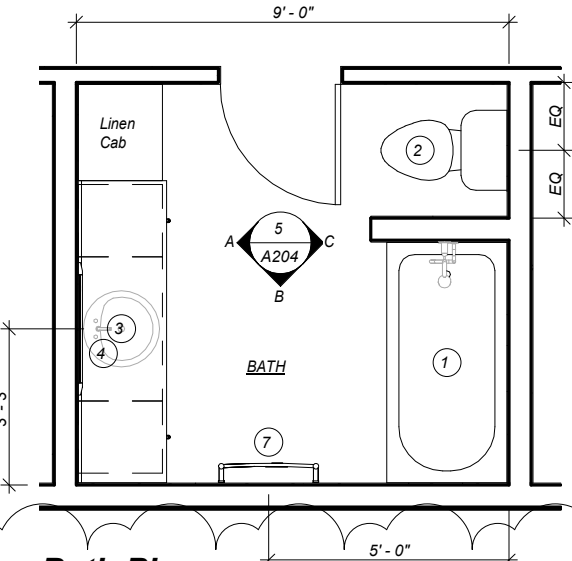2 Interior Elevations - Master Bath
1/4" = 1'-0"



3 Bath Plan
1/4" = 1'-0"

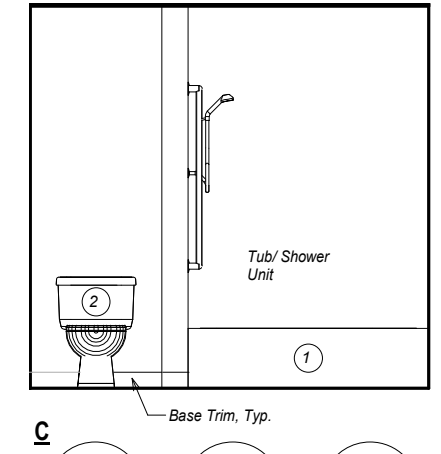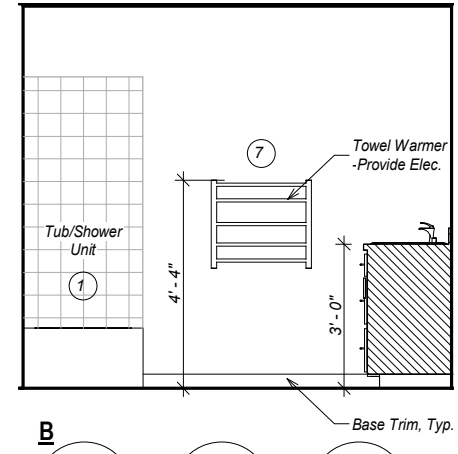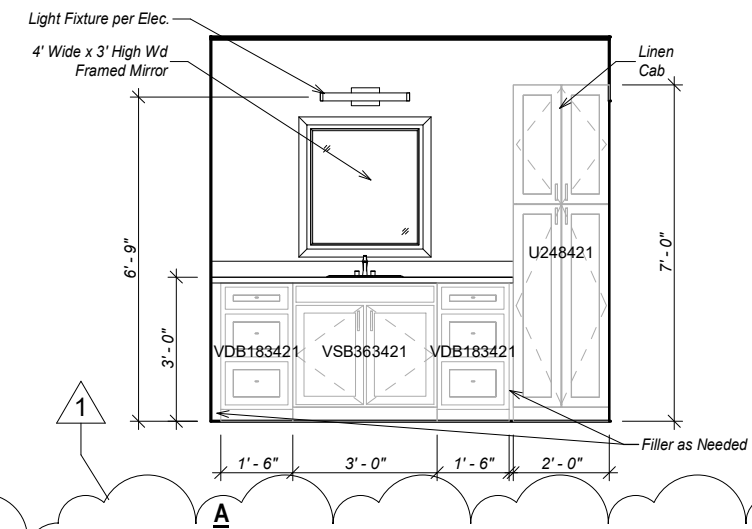

4 Interior Elevations - Bath
1/4" = 1'-0"

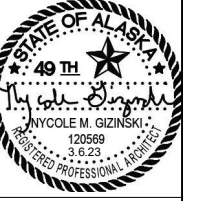
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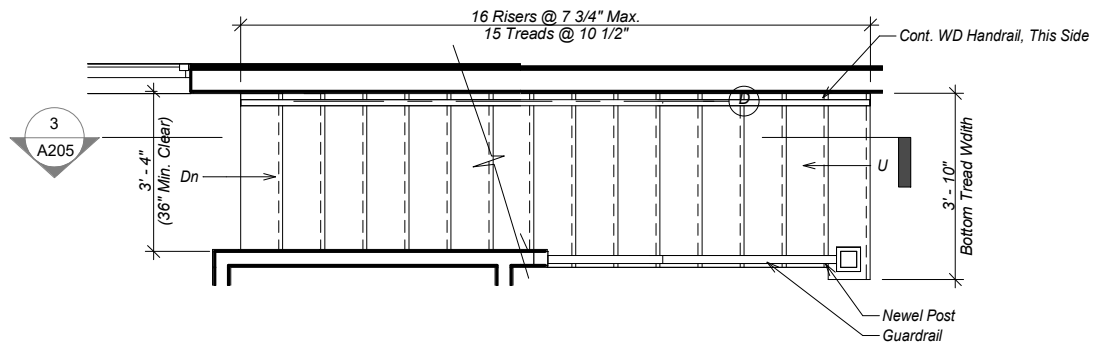
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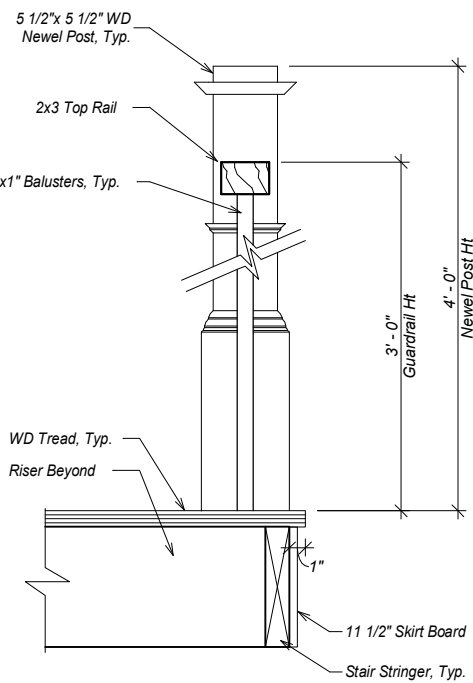
SHEET DESCRIPTION:
Enlarged Plans

A204


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25 of 28




1 Stair Plan
1/4" = 1'-0"



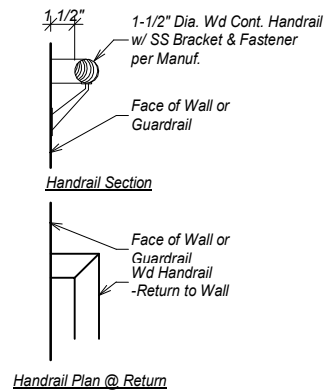
2 Guard Rail Detail
1" = 1'-0"



5 Handrail Detail
1" = 1'-0"

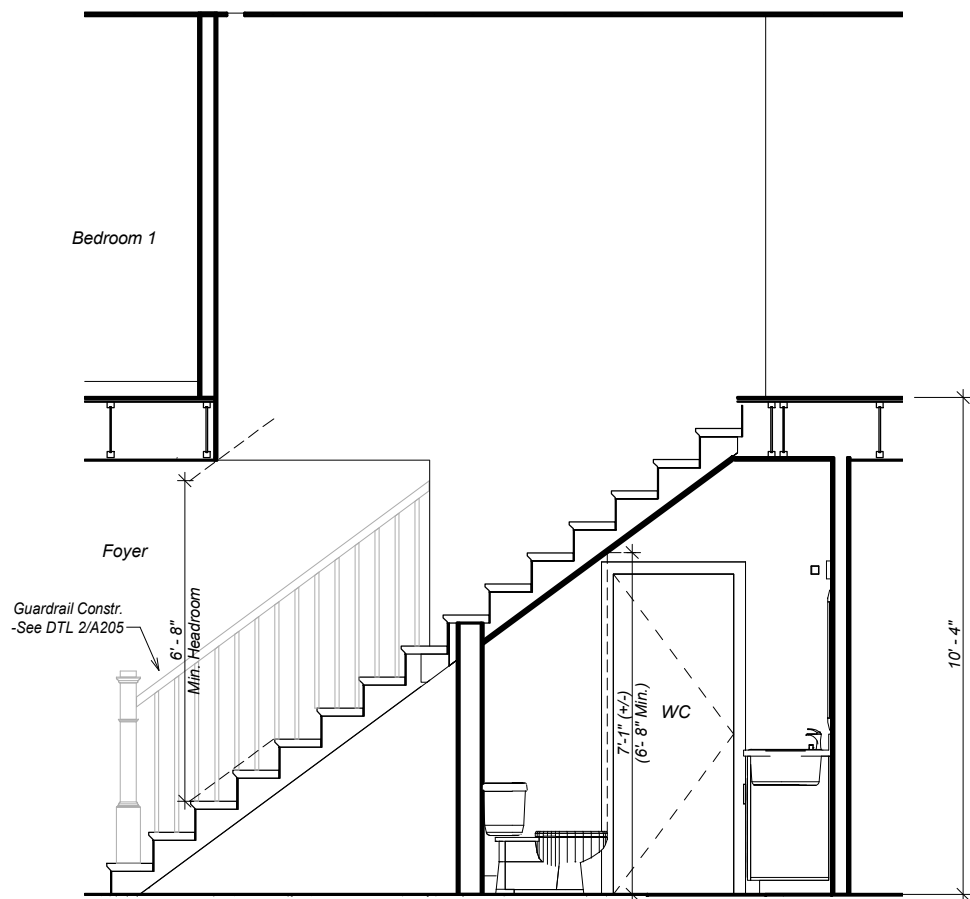

3 Stair Section
1/4" = 1'-0"

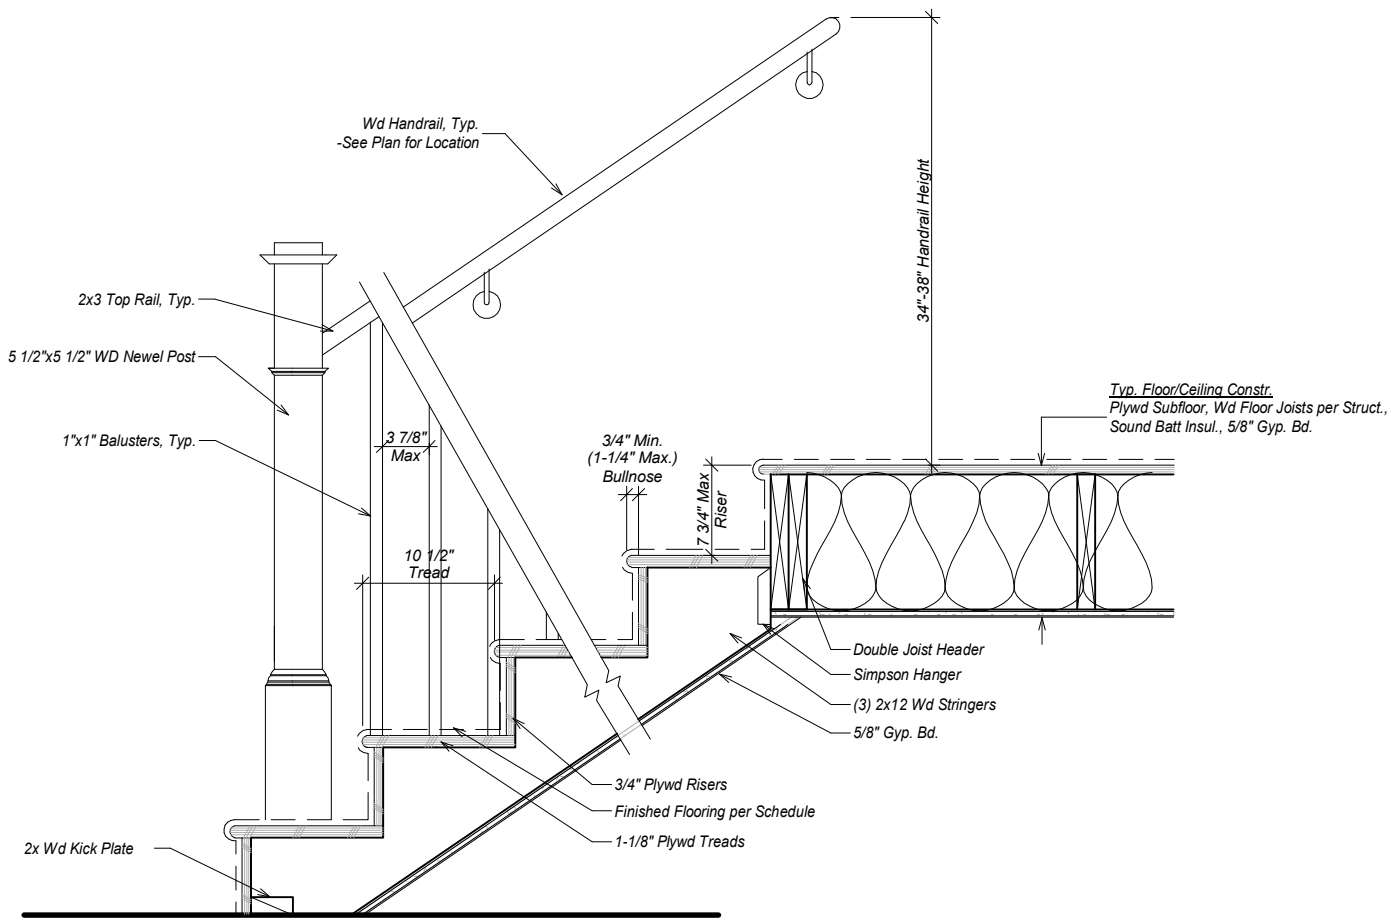

4 Typ. Stair Detail
3/4" = 1'-0"

REVISIONS:


REV #5 3.17.22

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SHEET DESCRIPTION:
Stair Plans & Details

A205

SHEET:
26 of 28

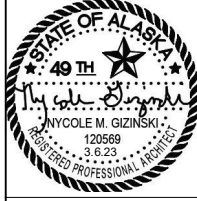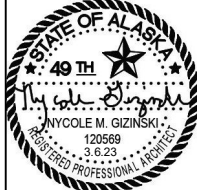
REVISIONS:
REV #1: 6.8.24

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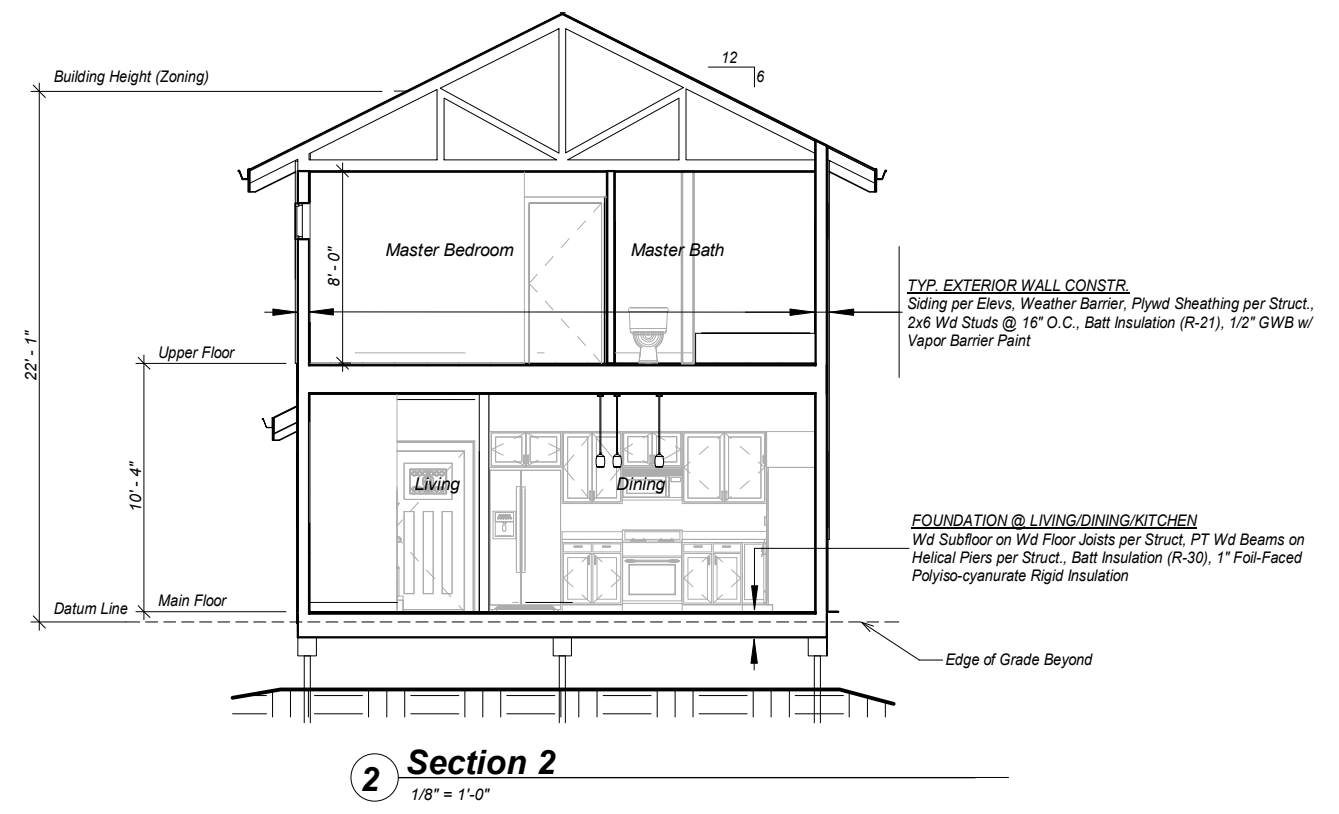
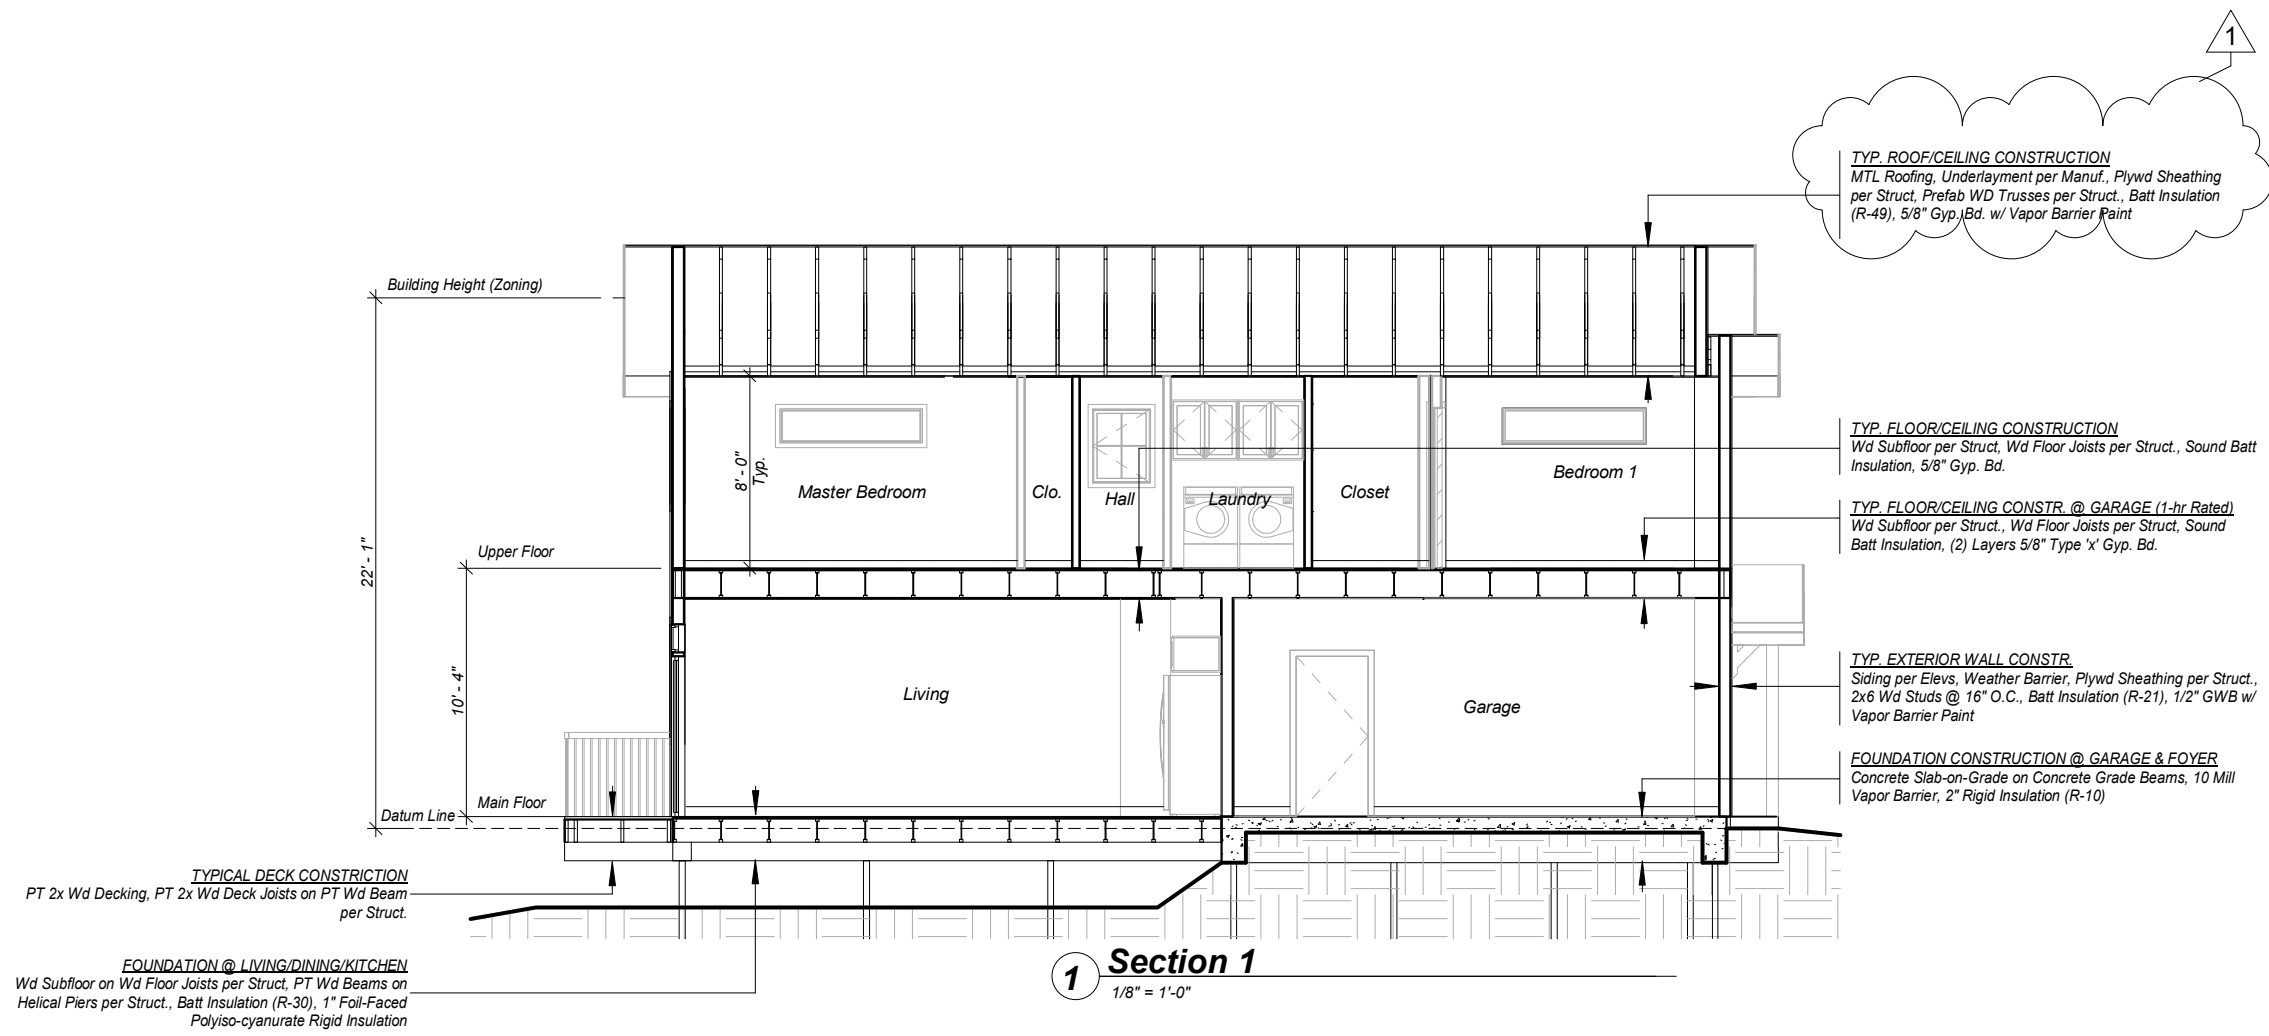
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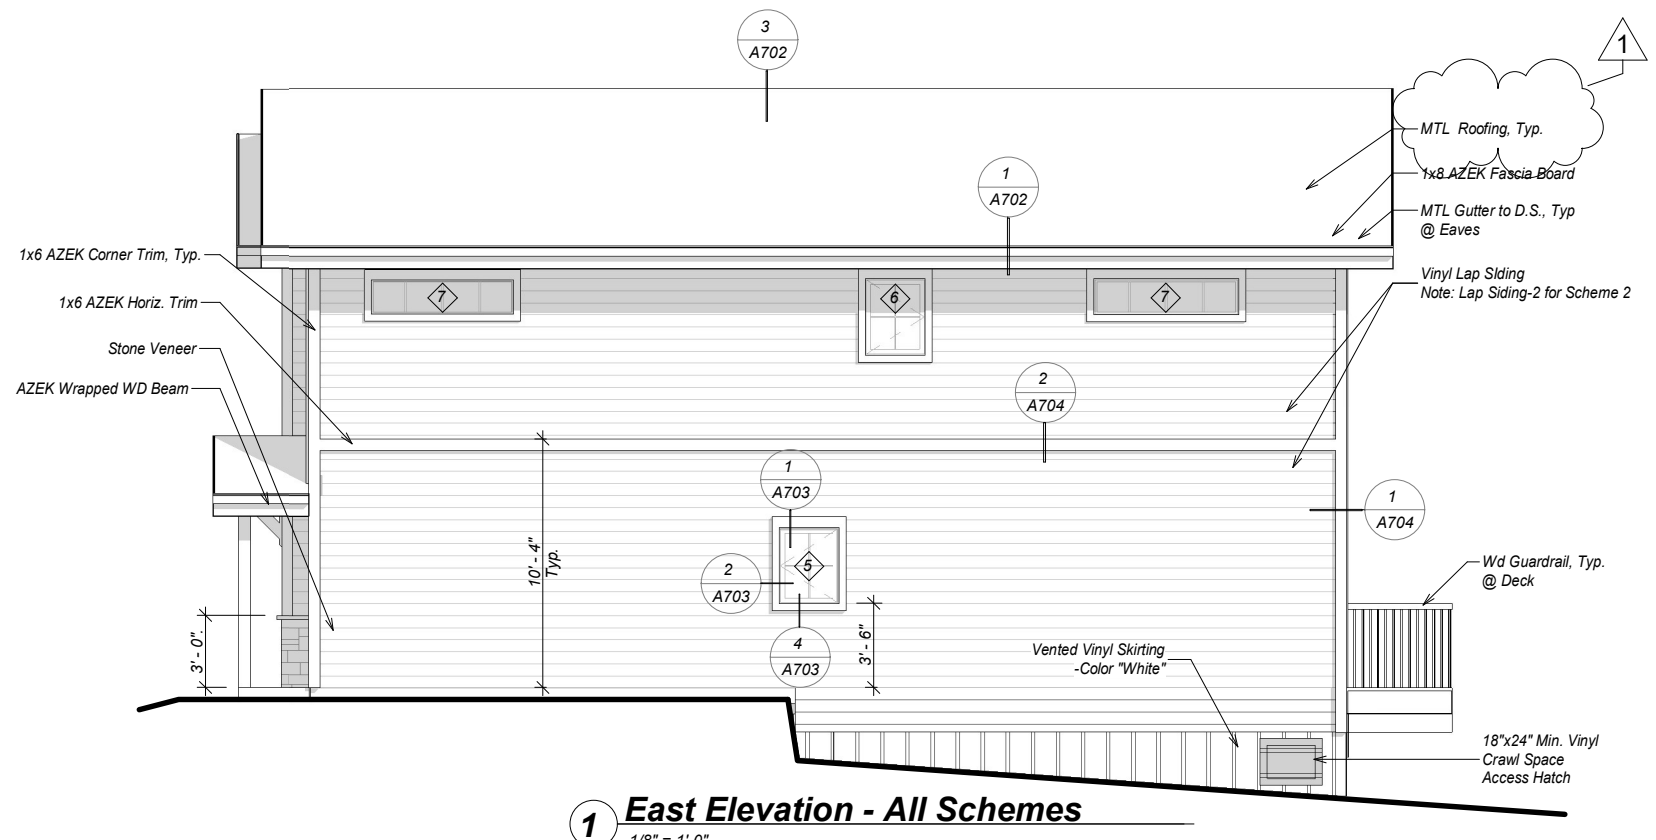
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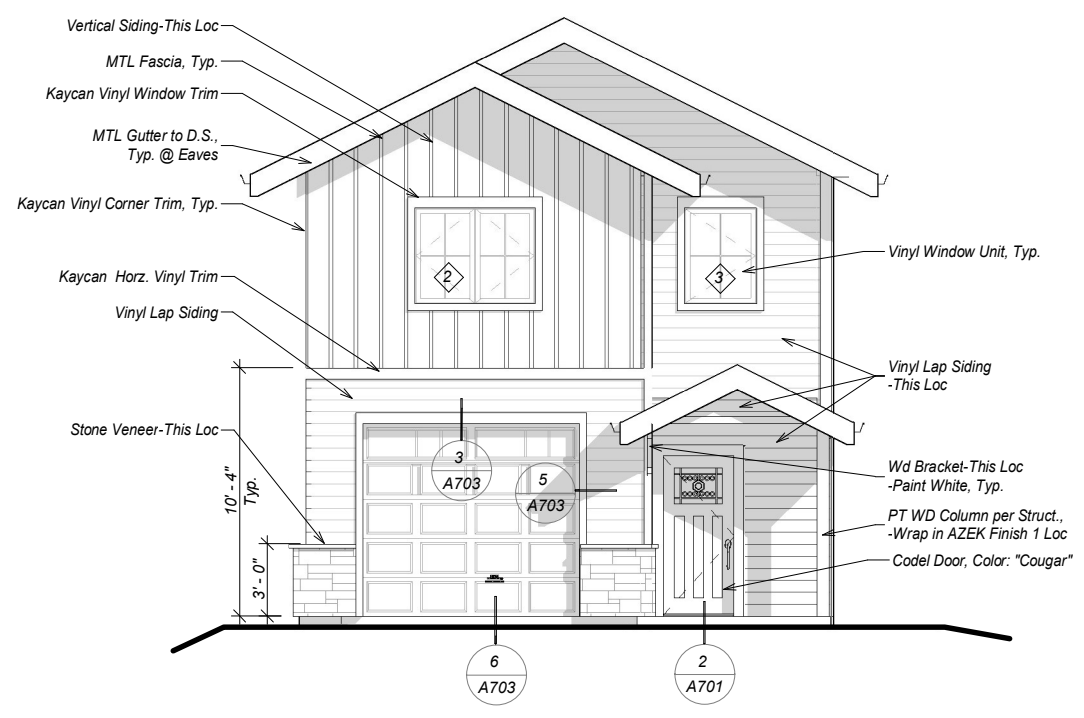
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Sections
A300
SHEET:
27 of 28






1 East Elevation - All Schemes
 1/8" = 1'-0"

EXTERIOR SIDING AND TRIM SCHEDULE
 Manufacturer: Kaycan
Scheme 1 (Odd Numbered Units):
 Vertical Siding: "Slate Grey"
 Lap Siding: "Slate"
 Trim: "White"
 Stone Veneer: Elderado Stone, Cliffstone Series, Color: "Whitebark"
Scheme 2 (Even Numbered Units):
 Lap Siding-1: "Slate Grey"
 Lap Siding-2: "Slate"
 Trim: "White"
 Stone Veneer: Elderado Stone, Cliffstone Series, Color: "Whitebark"
 Note: Coordinate final color selection w/ Owner.



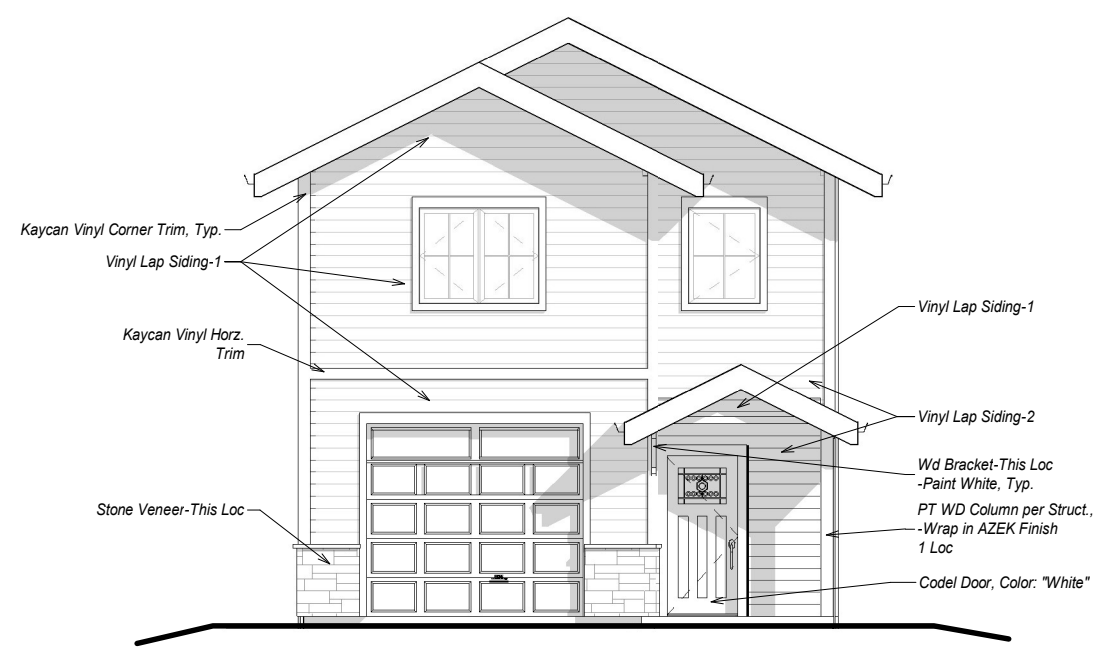3 North Elevation - Scheme 1
 1/8" = 1'-0"



2 North Elevation - Scheme 2
 1/8" = 1'-0"

REVISIONS:
 REV #1: 6.8.24

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 Single Family Dwelling

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SHEET DESCRIPTION:
 Elevations
A400
 SHEET:
 28 of 28


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REV #1: 6.8.24
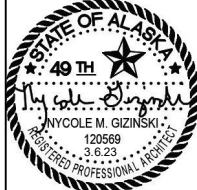
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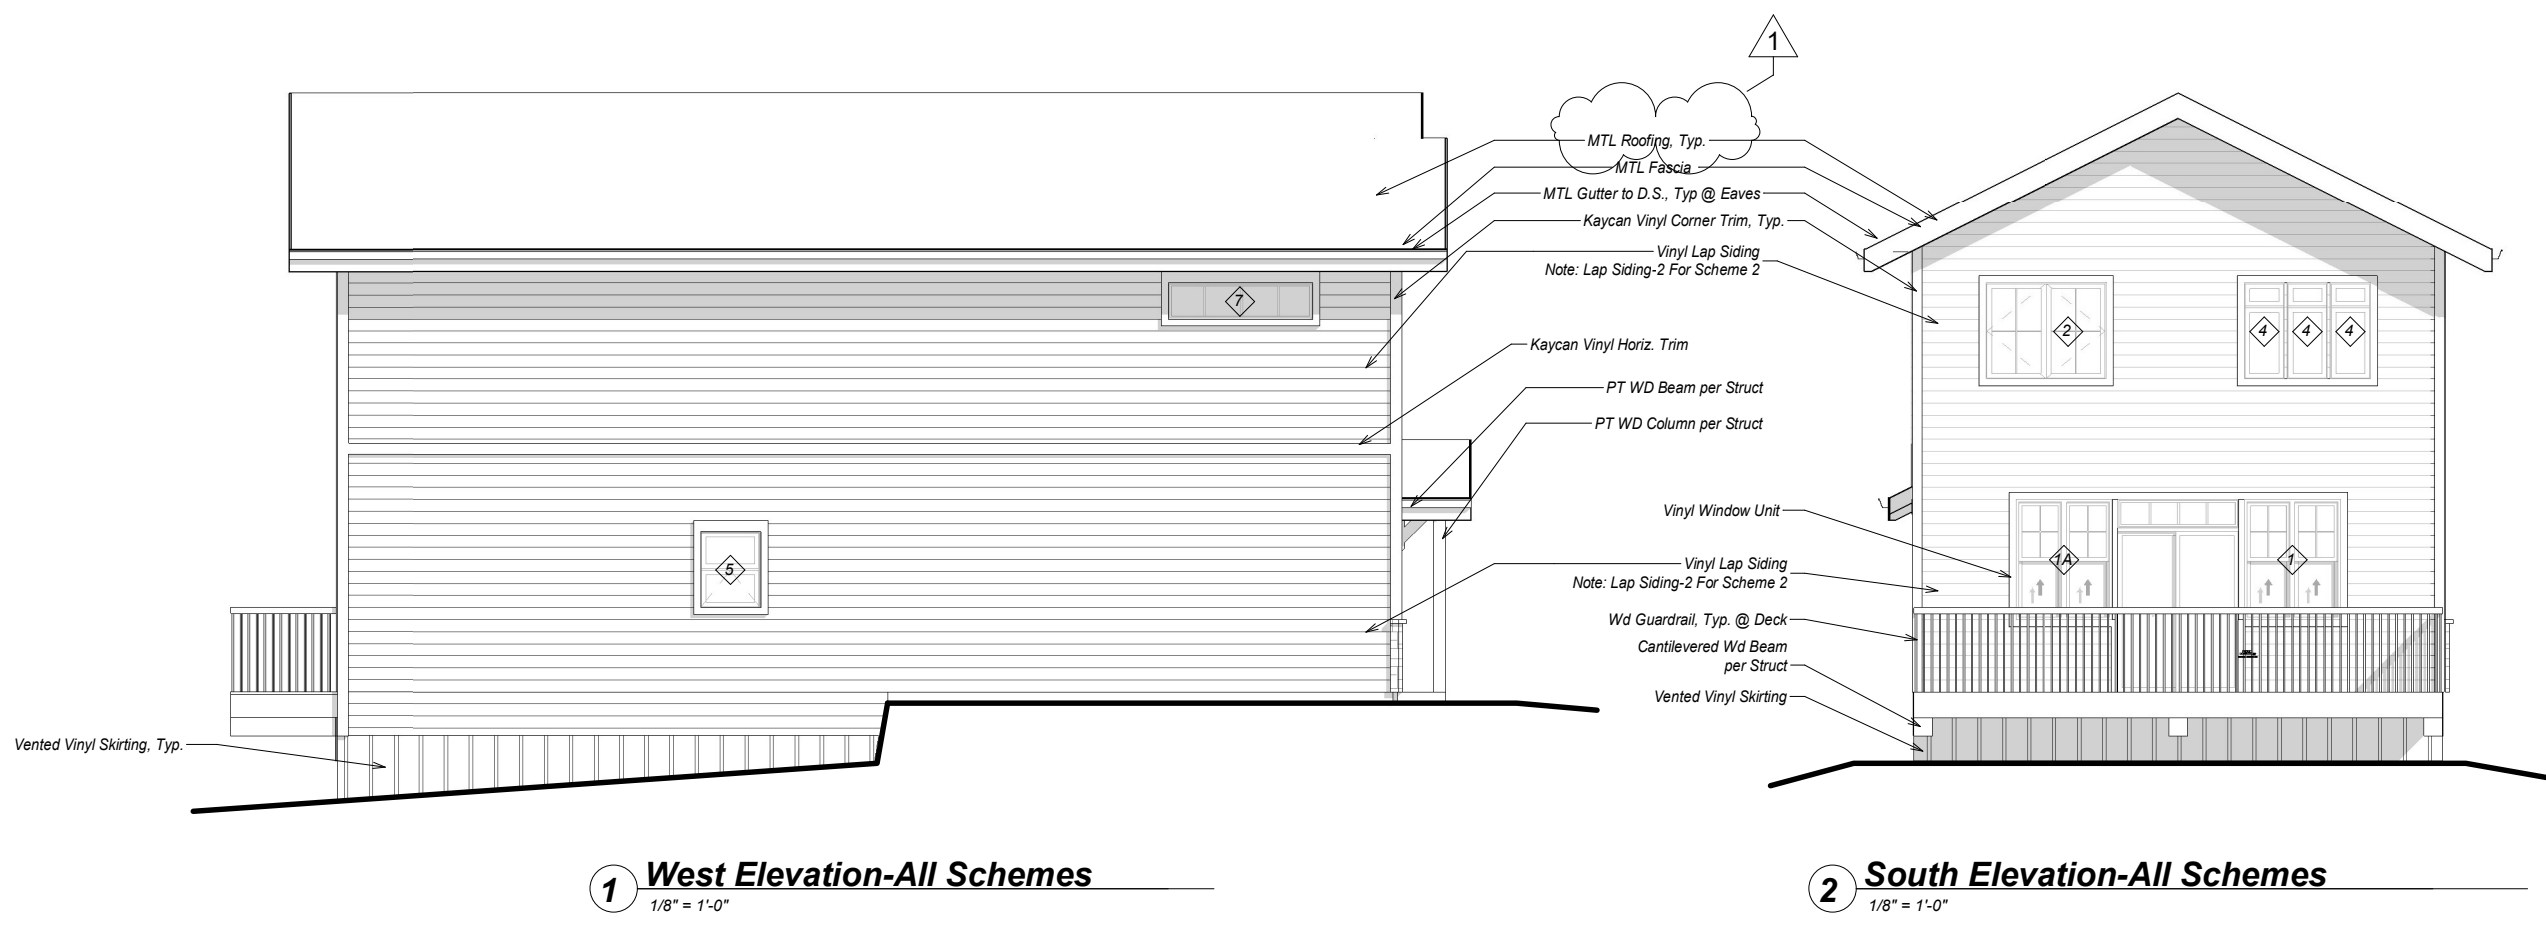
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SHEET DESCRIPTION:
Elevations

A401

SHEET:
29 of 28



1 West Elevation-All Schemes
1/8" = 1'-0"

2 South Elevation-All Schemes
1/8" = 1'-0"

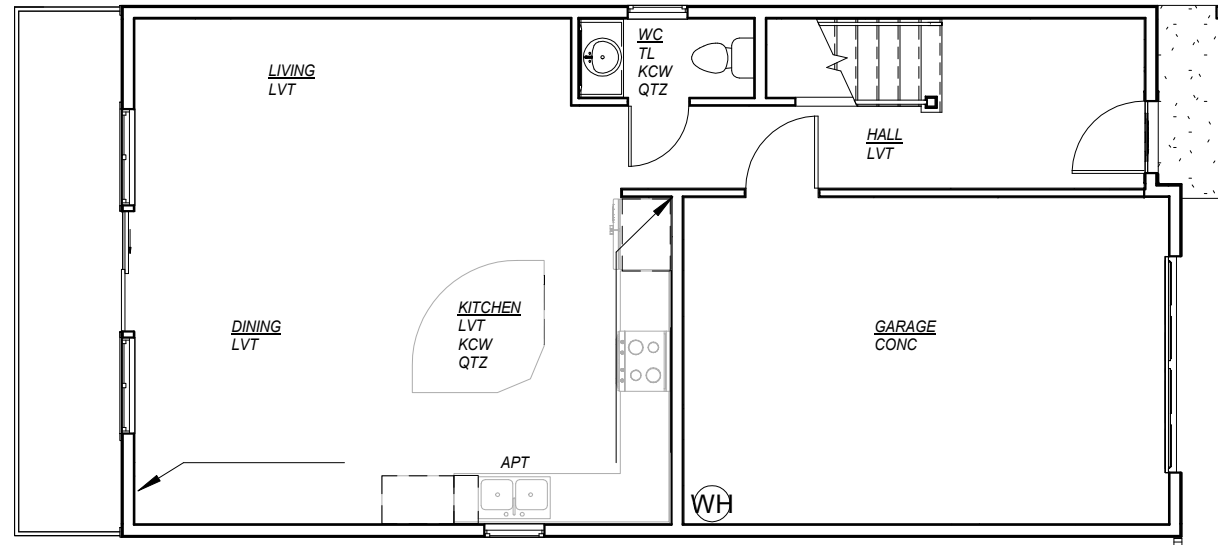
EXTERIOR SIDING AND TRIM SCHEDULE

Manufacturer: Kaycan


Scheme 1 (Odd Numbered Units):
Vertical Siding: "Slate Grey"
Lap Siding: "Slate"
Trim: "White"
Stone Veneer: Elderado Stone, Cliffstone Series,
Color: "Whitebark"

Scheme 2 (Even Numbered Units):
Lap Siding-1: "Slate Grey"
Lap Siding-2: "Slate"
Trim: "White"
Stone Veneer: Elderado Stone, Cliffstone Series,
Color: "Whitebark"

Note: Coordinate final color selection w/ Owner.



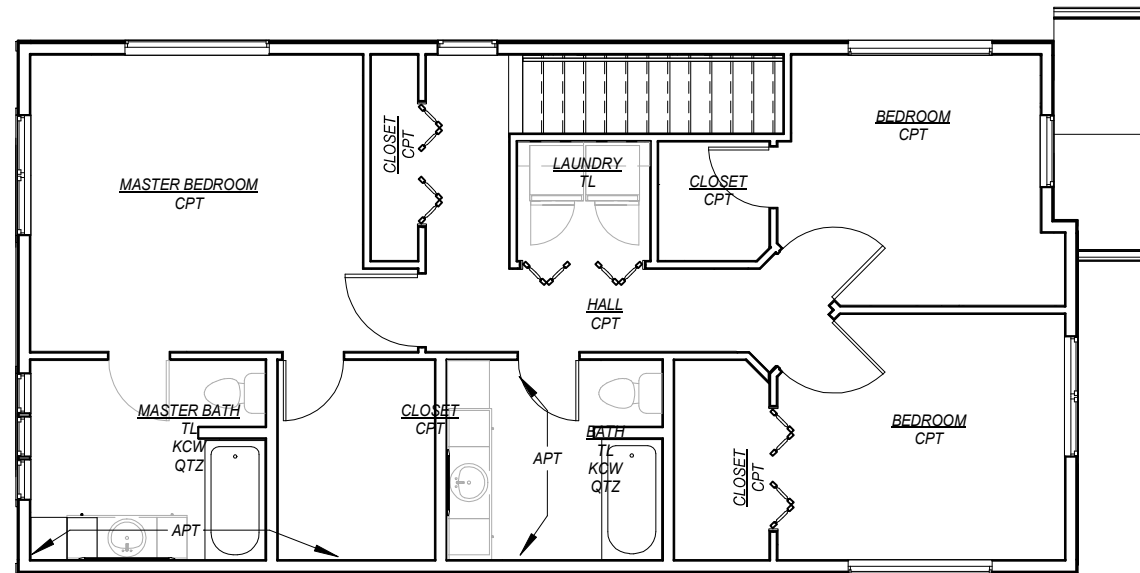1 FF&E Scheme 1 Plan-Main Level
1/8" = 1'-0"



2 FF&E Scheme 1 Plan-Upper Level
1/8" = 1'-0"

MATERIALS - SCHEME 1 (ODD NUMBERED UNITS)

FINISH MATERIAL LEGEND		FINISH MATERIAL SPECIFICATIONS	
Flooring:		Luxury Vinyl Tile (LVT)	General Wall & Ceiling Paint (GPT)
CONC:	Concrete-Sealed	LVT	Manuf: TAS Flooring
LVT:	Luxury Vinyl Tile	CPT	Series: Fortitude ABA
CPT:	Carpet	TL	Color: Ranger
TL:	Tile		Finish: Eggshell
Trim:		Floor & Base Tile (TL)	Accent Wall Paint (APT)
BT	Base Trim	Manuf: Daltile	Manuf: Pittsburgh Paints
WT	Window & Door Trim	Series & Shape: Attache, Rectangle	Color: "Shadow Taupe" PPG14-01
Paint:		Color: Meta Beige SA05	Finish: Eggshell
GPT	General Wall & Ceiling Paint	Carpet (CPT)	Casework (KCW)
APT	Accent Wall Paint (See Plan for Locs)	Manuf: Shaw Contract	Manuf: Kemper Cabinets
Casework:		Syle: Statement 5A257	Material: Hardwood
KCW:	Casework	Color: Refined 00220	Color: White
Countertops:		Base Trim (BT)	Door Style: Antrim
QTZ:	Quartz Countertop	WD-Painted White	Hardware: H118 Knob & H120 Pull
		Window Trim (WT)	Countertops (QTZ)
		WD-Painted White	Manuf: Pental Quartz
			Color: Cappuccino Polished

1. Base, Window, & Door Trim is Typical Throughout all Rooms U.O.N on the FF&E Plan.
2. All Walls and Ceilings throughout are to be General Wall & Ceiling Paint - GPT U.O.N. See FF&E Plan for Accent Paint-APT Locations.
3. See Interior Elevations for Drawer Knob Locs. All other Areas to be H120 Pull Type Hardware.

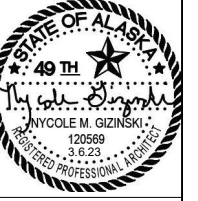
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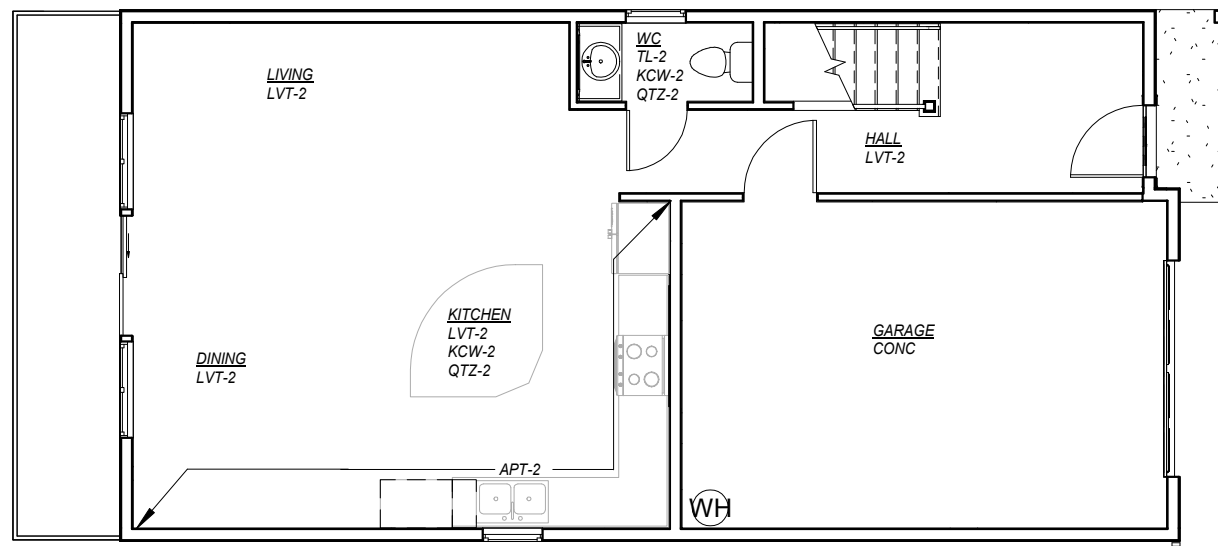
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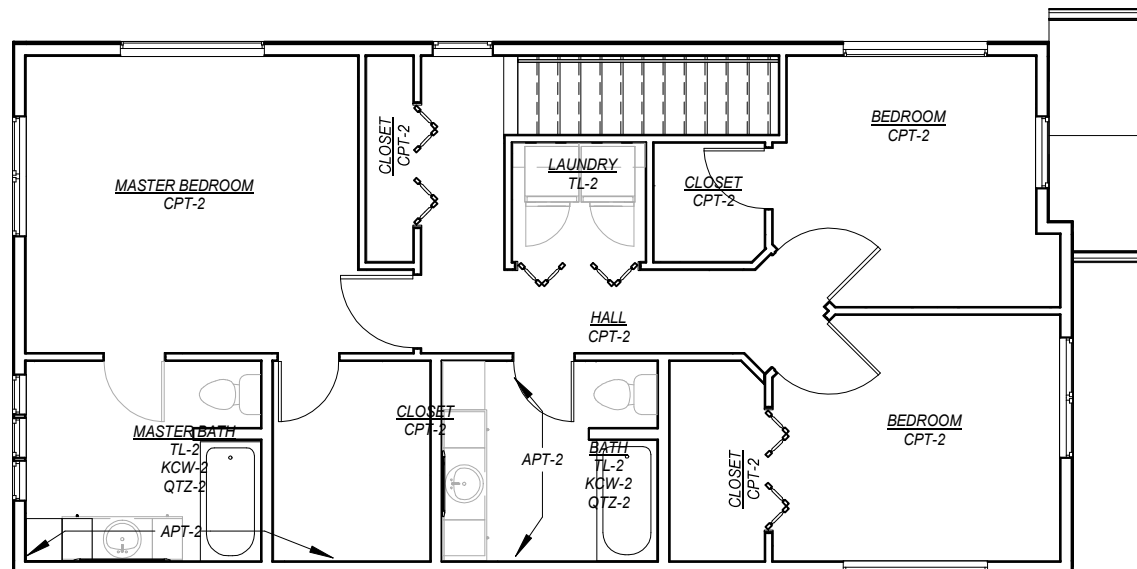
SHEET DESCRIPTION:
FF&E Scheme 1 Plans

A600

SHEET:
30 of 28



2 FF&E Scheme 2 Plan-Main Level
1/8" = 1'-0"



1 FF&E Scheme 2 Plan-Upper Level
1/8" = 1'-0"

MATERIALS - SCHEME 2 (EVEN NUMBERED UNITS)

FINISH MATERIAL LEGEND	FINISH MATERIAL SPECIFICATIONS			GENERAL NOTES
Flooring: CONC: Concrete-Sealed LVT-2 Luxury Vinyl Tile CPT-2 Carpet TL-2 Floor & Base Tile Trim: BT Base Trim WT Window Trim Paint: GPT-2 General Wall & Ceiling Paint APT-2 Accent Wall Paint Casework: KCW-2 Kitchen Casework BCW-2 Bathroom Casework Countertops: QTZ-2 Quartz Countertop	Luxury Vinyl Tile (LVT-2) Manuf: TAS Flooring Series: Fortitude ABA Color: Mercedes Carpet (CPT-2) Manuf: Shaw Contract Syle: Reimagine 5A256 Color: Ponder 00770 Floor & Base Tile (TL-2) Manuf: Daltile Series & Shape: Attache, Rectangle Color: "Meta White" SA04 Base Trim (BT) WD-Painted White Window Trim (WT) WD-Painted White	General Wall Paint (GPT-2) Manuf: Pittsburgh Paints Color: "Off White" PPG1024-1 Finish: Eggshell Accent Wall Paint (APT-2) Manuf: Pittsburgh Paints Color: Moth Grey PPG1024-4 Finish: Eggshell Kitchen Casework (KCW-2) Manuf: Kemper Cabinets Material: Maple Color: Thatch Door Style: Antrim Hardware: H120 Pull	Bathroom Casework (BCW-2) Manuf: Kemper Cabinets Material: Hardwood Color: Maritime Door Style: Antrim Hardware: H118 Knob & H120 Pull Countertops (QTZ-2) Manuf: Pental Quartz Color: Valley White Polished	1. Base, Window, & Door Trim is Typical Throughout all Rooms U.O.N on the FF&E Plan. 2. All Walls and Ceilings throughout are to be General Wall & Ceiling Paint - GPT U.O.N. See FF&E Plan for Accent Paint-APT Locations. 3. See Interior Elevations for Drawer Knob Locs. All other Areas to be H120 Pull Type Hardware.

REVISIONS:

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Single Family Dwelling

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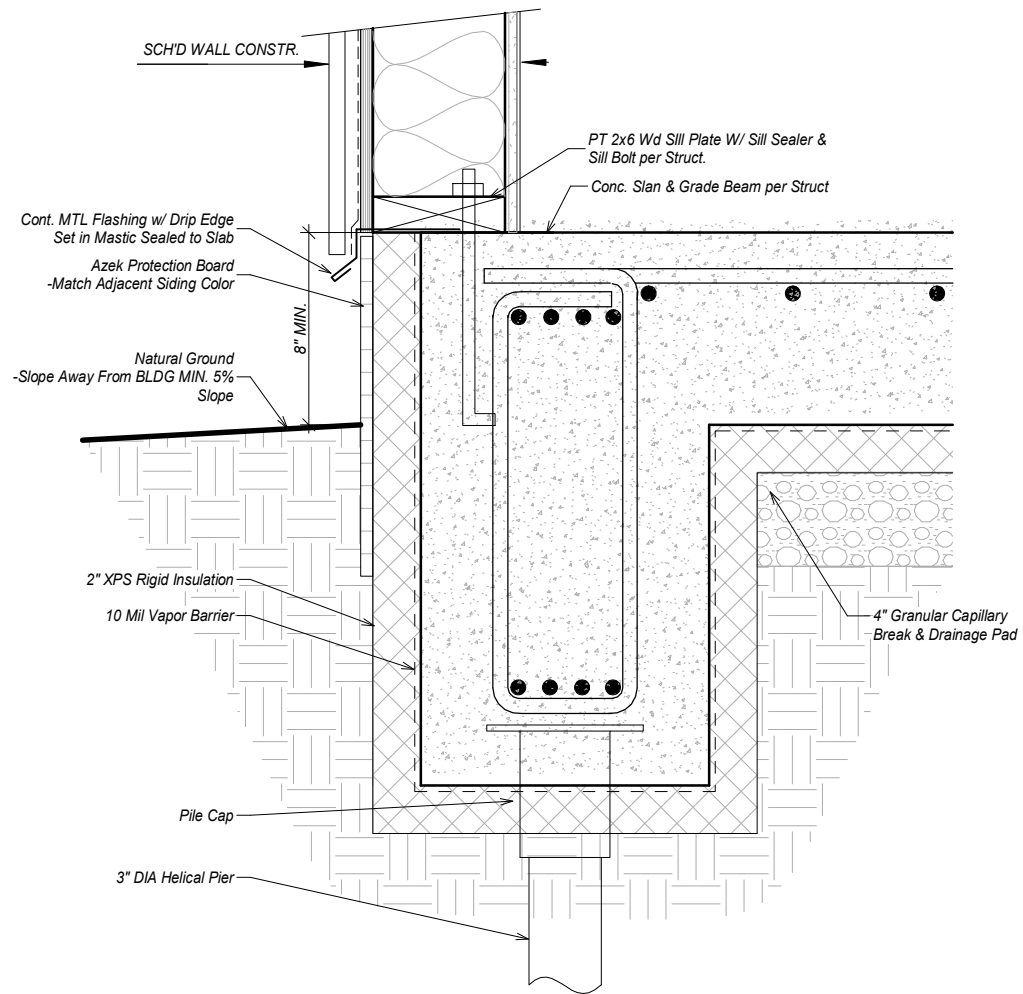
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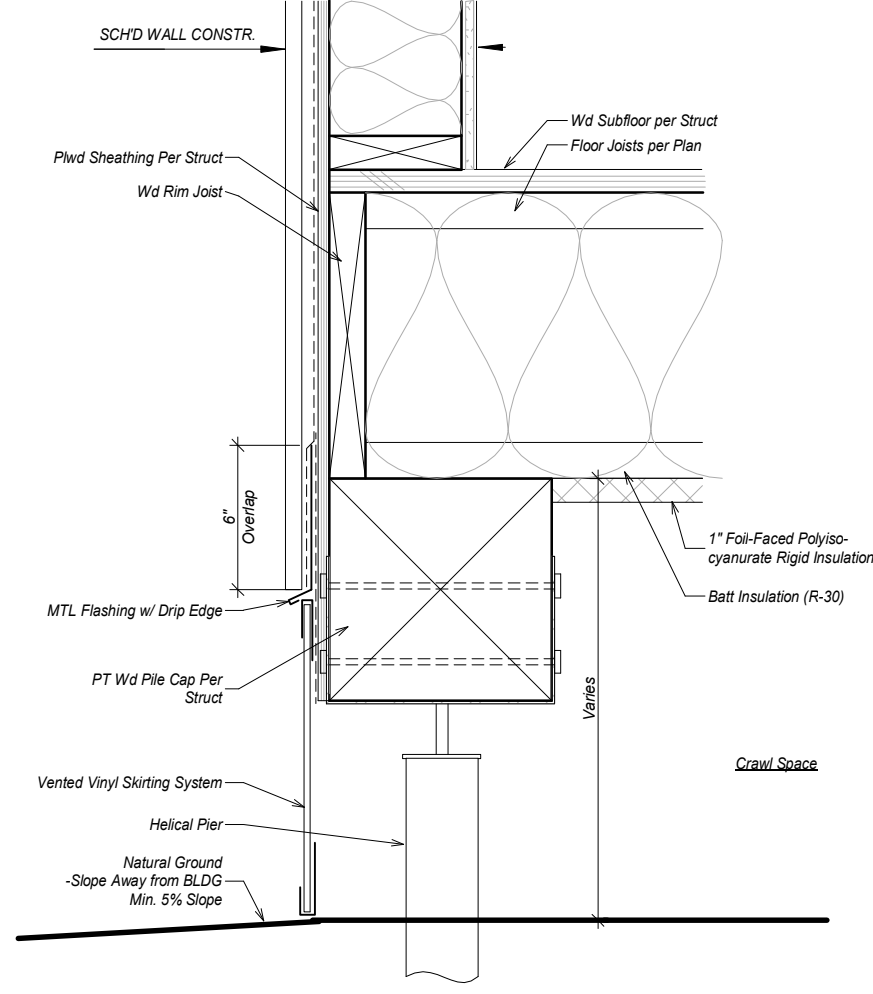
SHEET DESCRIPTION:
FF&E Scheme2 Plans

A601

SHEET:
31 of 28



1 Foundation Detail @ Conc. Slab
1 1/2" = 1'-0"



2 Foundation @ Wood Beams
1 1/2" = 1'-0"

REVISIONS:

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Single Family Dwelling

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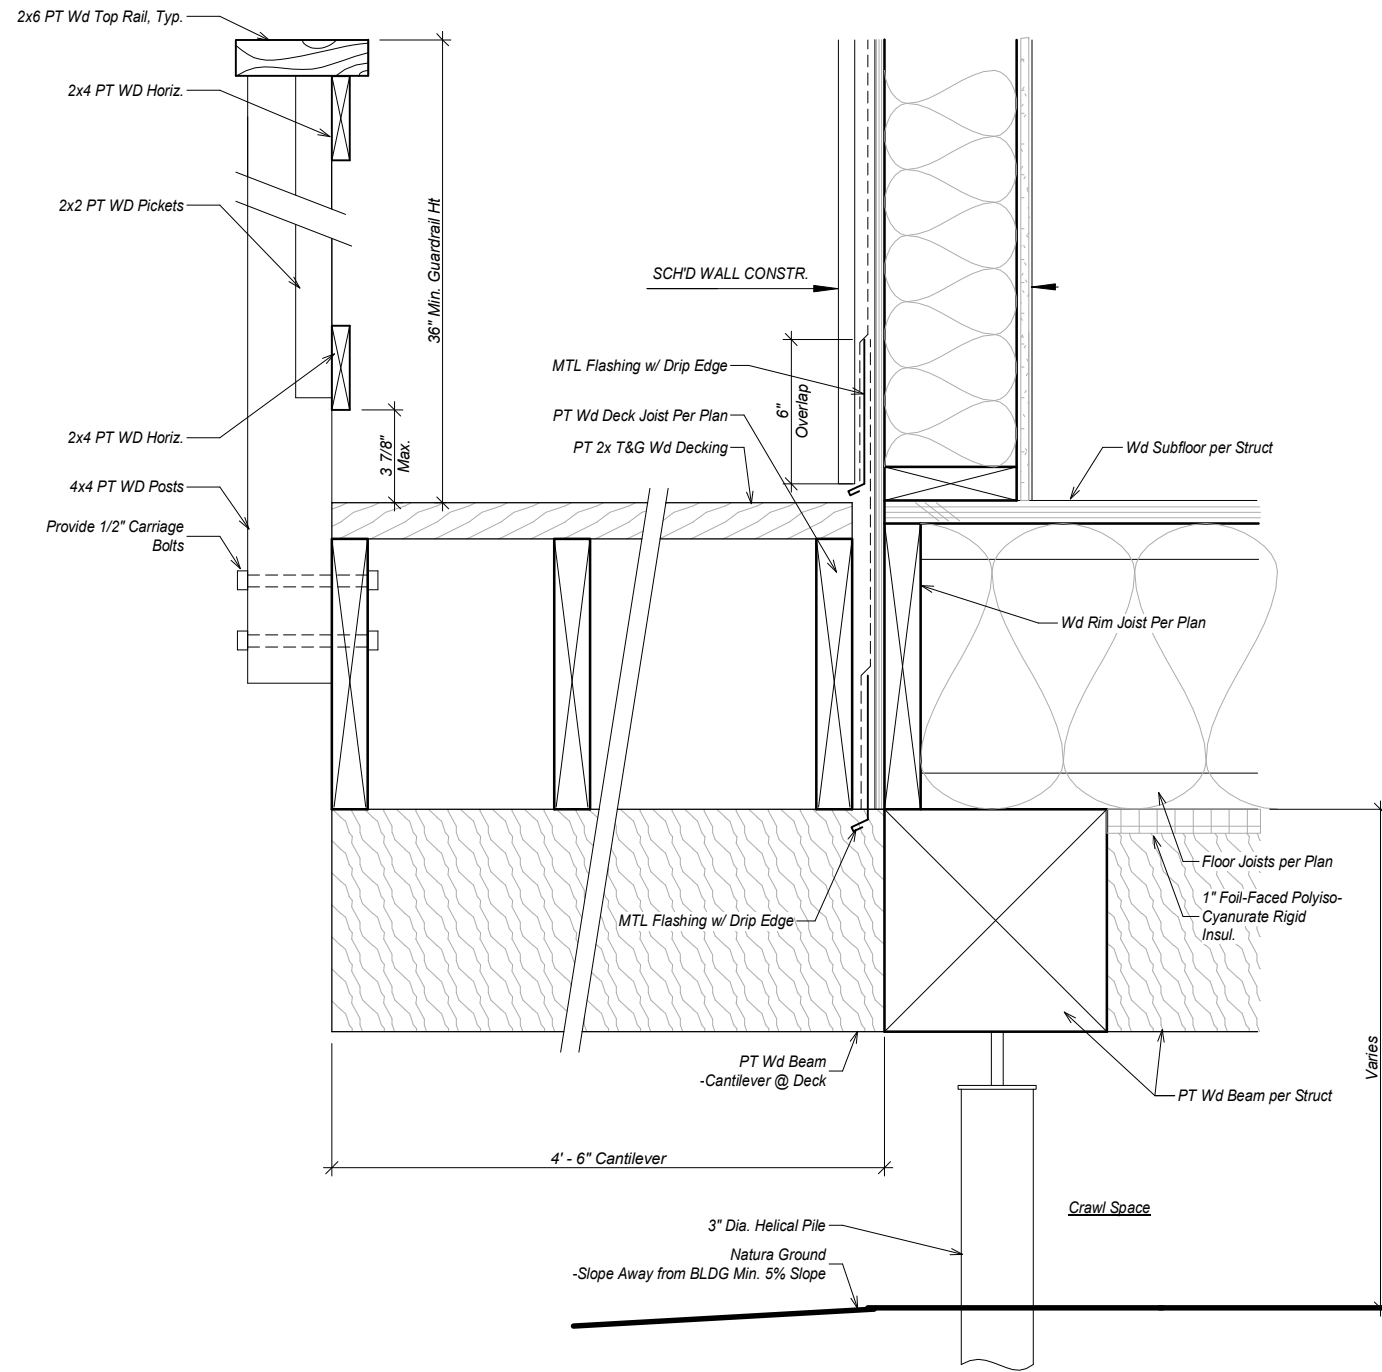
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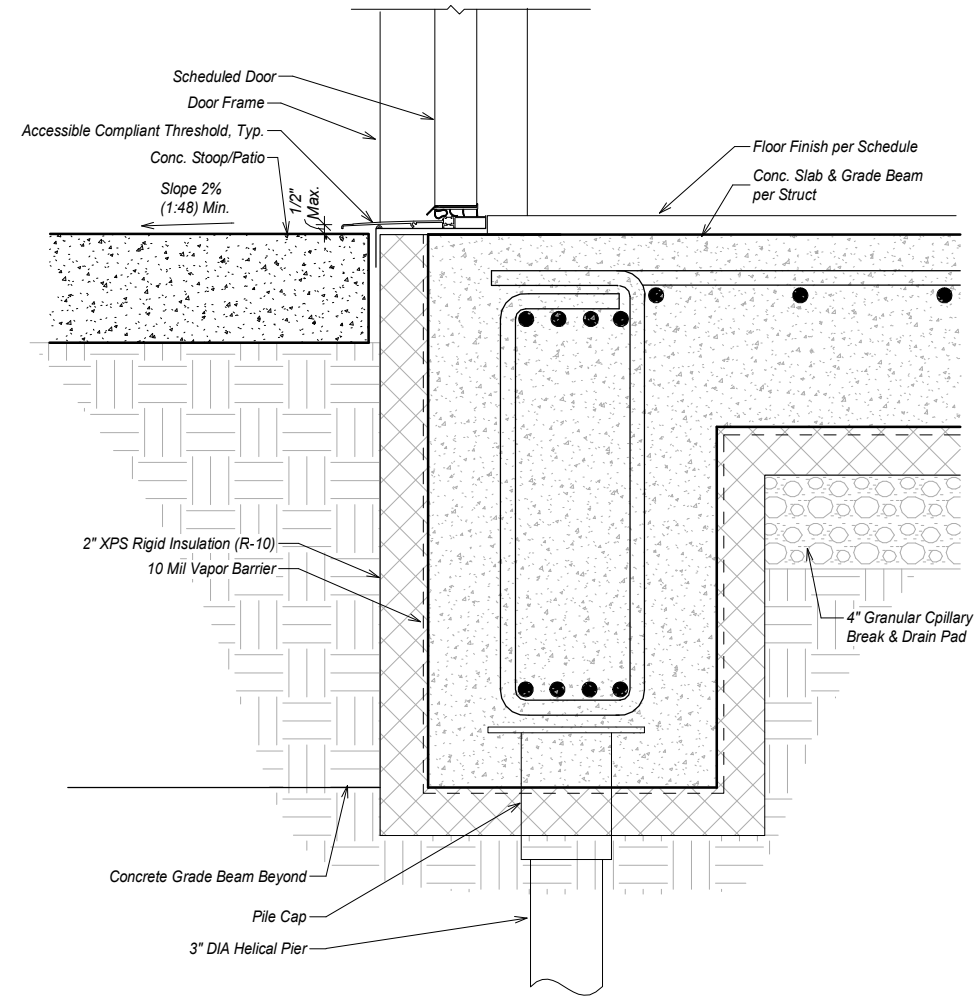
SHEET DESCRIPTION:
Details

A700

SHEET:
32 of 28



1 **Typ. Deck Detail**
1 1/2" = 1'-0"



2 **Door Threshold @ Covered Entry**
1 1/2" = 1'-0"

REVISIONS:

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Single Family Dwelling

STATUS:
CONSTRUCTION DOCUMENTS

DRAWN BY: NMG
CHECKED BY: NMG
DATE: 3.6.23
PROJECT #: 222321.10

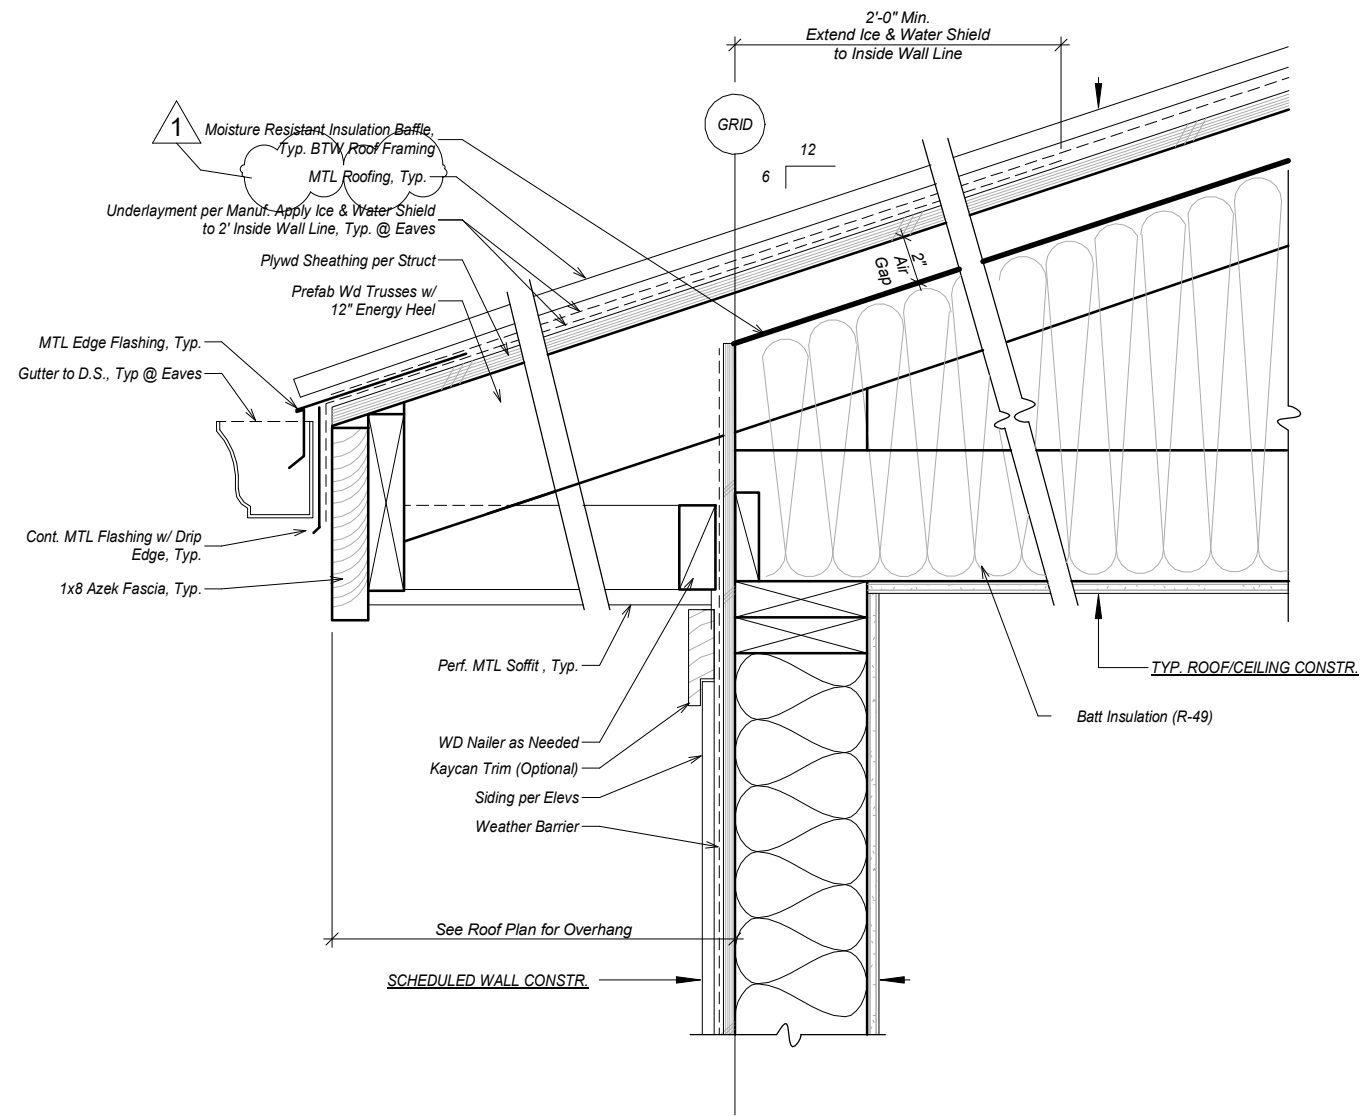
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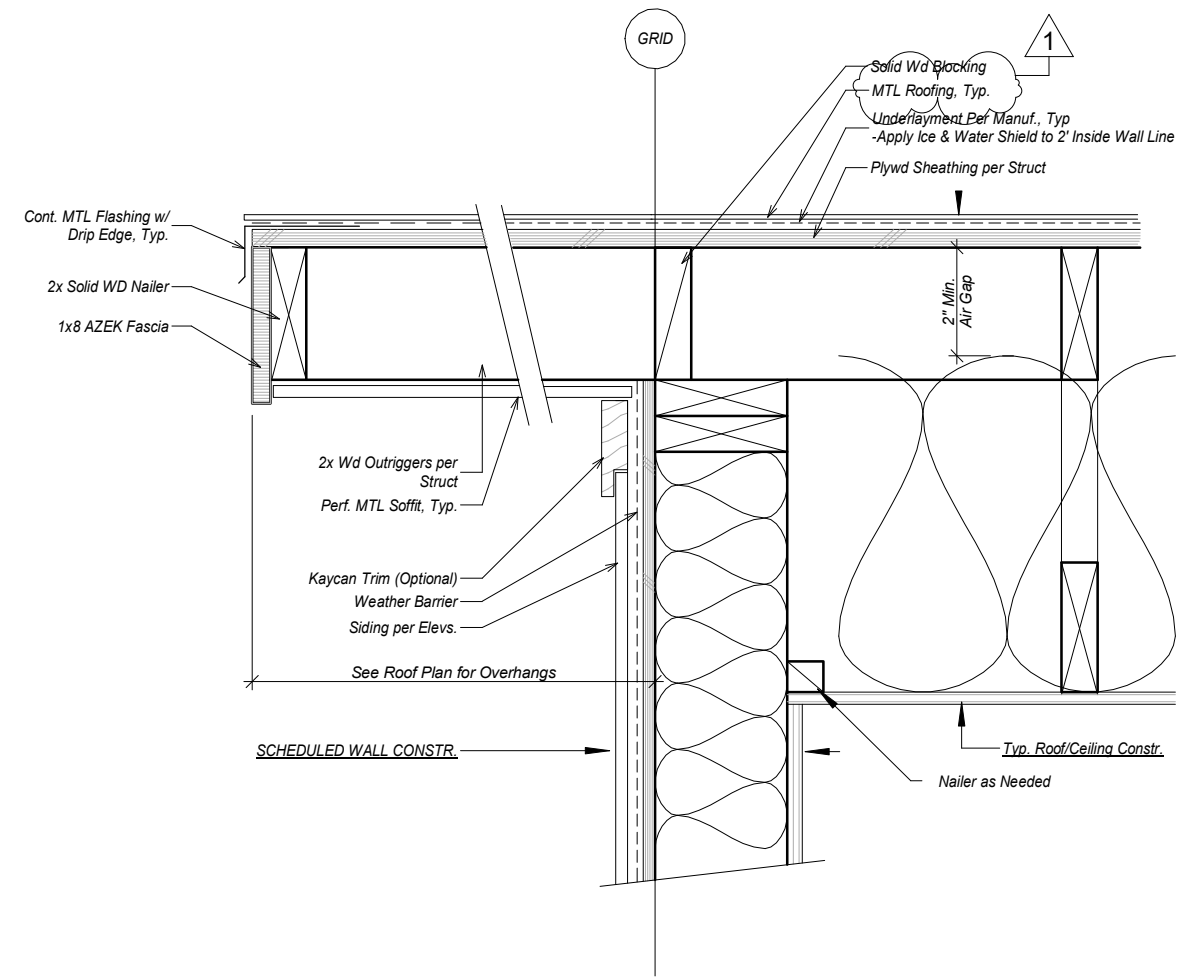
SHEET DESCRIPTION:
Details

A701

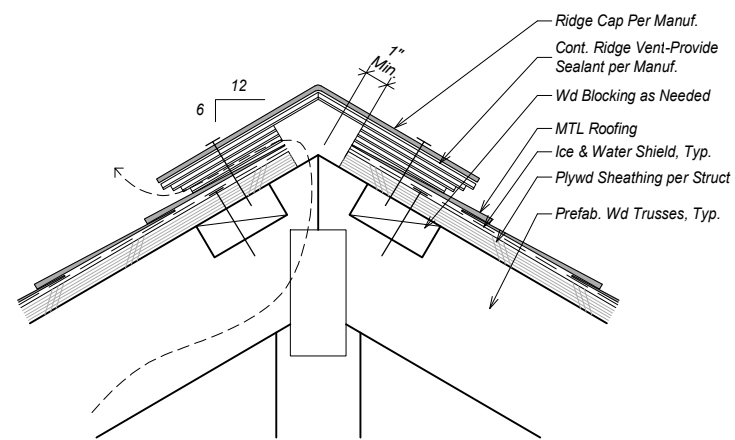
SHEET:
33 of 28



1 **Typ. Roof Eave-1 hr Rated (Ga File No. RC 2601)**
 1 1/2" = 1'-0"



2 **Typ. Roof Rake**
 1 1/2" = 1'-0"



3 **Typ. Ridge Detail**
 1 1/2" = 1'-0"


REVISIONS:
REV #1: 6.8.24

THRHA
 Single Family Dwelling

STATUS:
CONSTRUCTION DOCUMENTS

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 CHECKED BY: NMG
 DATE: 3.6.23
 PROJECT #: 222321.10

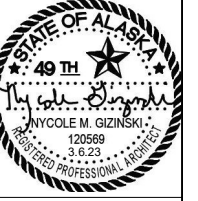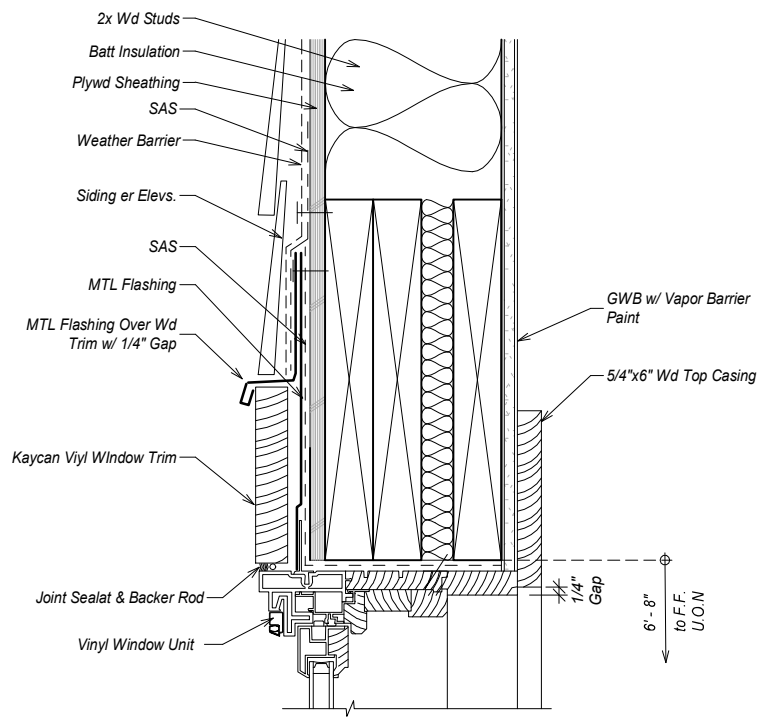
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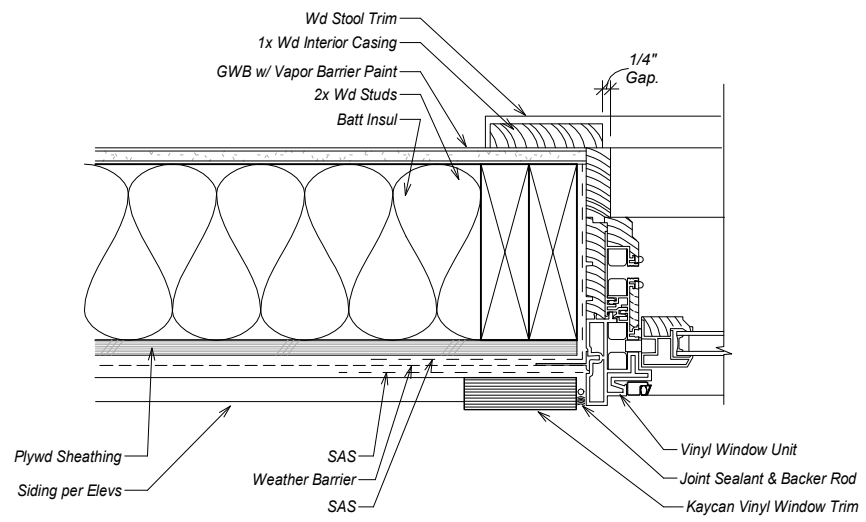
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A702


SHEET:
 34 of 28




1 Typ. Window Head
1:6



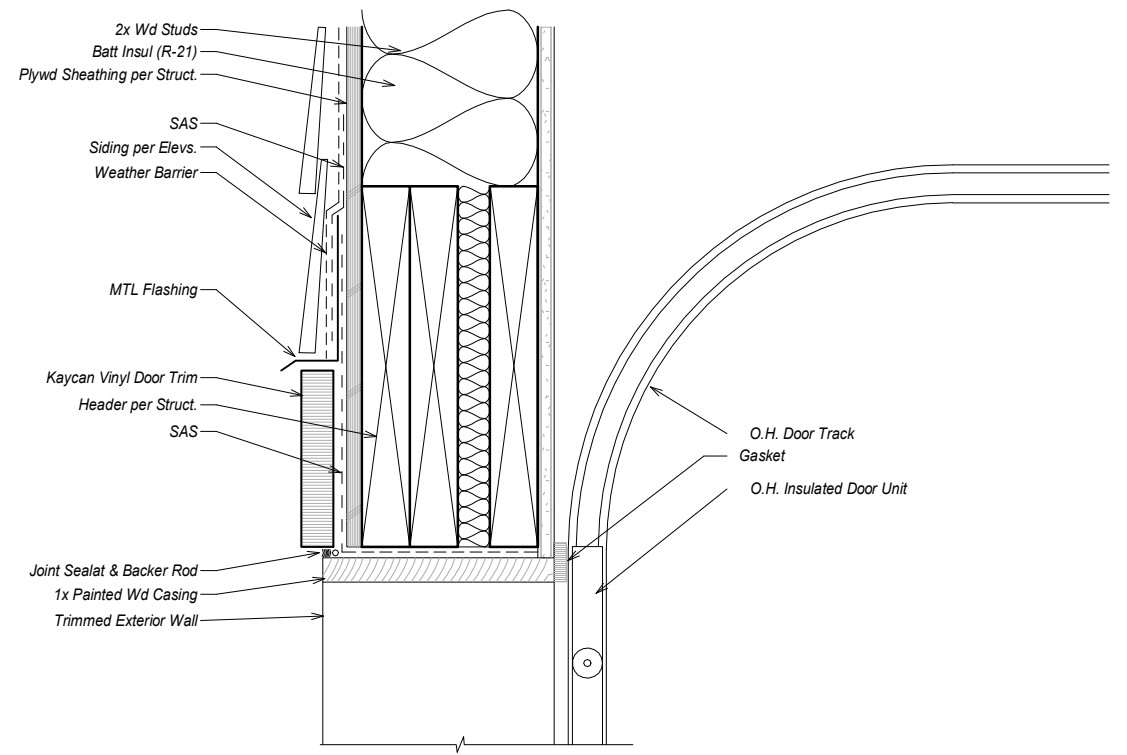
2 Typ. Window Jamb
1:6




3 Overhead Door Head
1:6

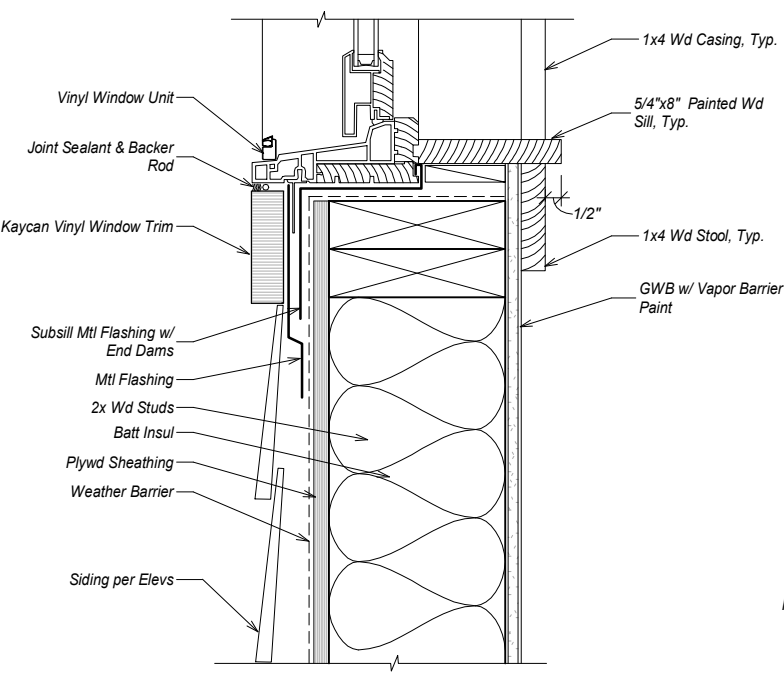

4 Typ. Window Sill
1:6

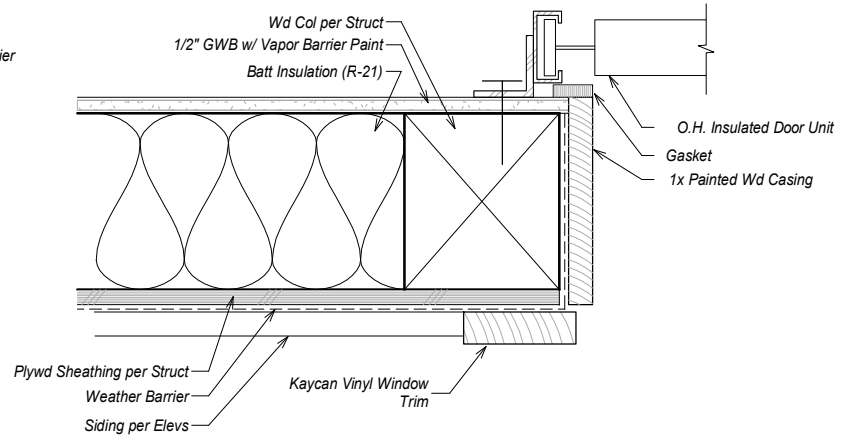

5 Overhead Door Jamb
1:6

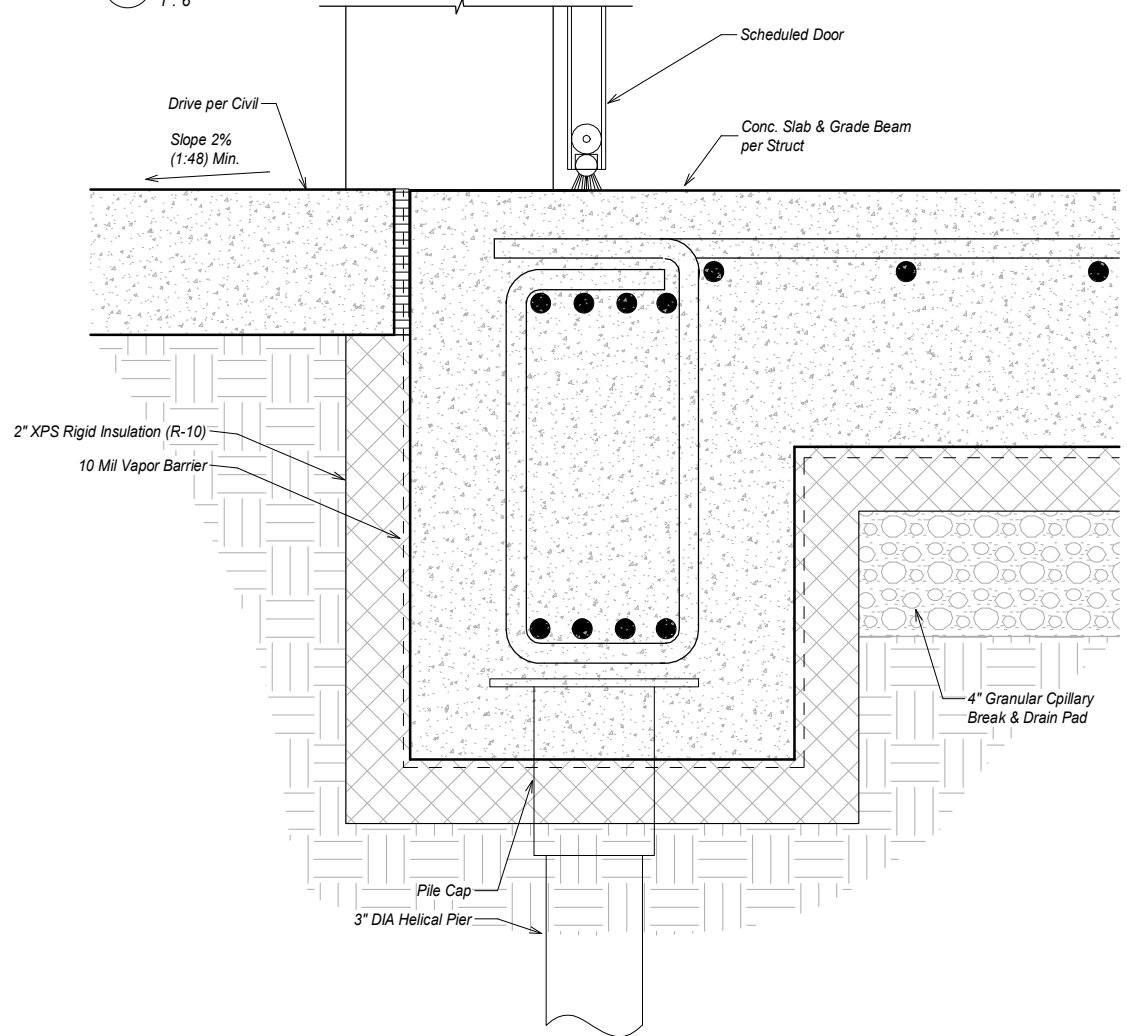

6 Overhead Door Threshold
1:6

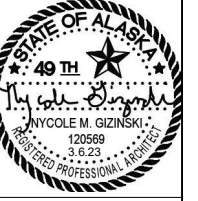
REVISIONS:

THRHA
Single Family Dwelling

STATUS:
CONSTRUCTION DOCUMENTS

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DATE: 3.6.23
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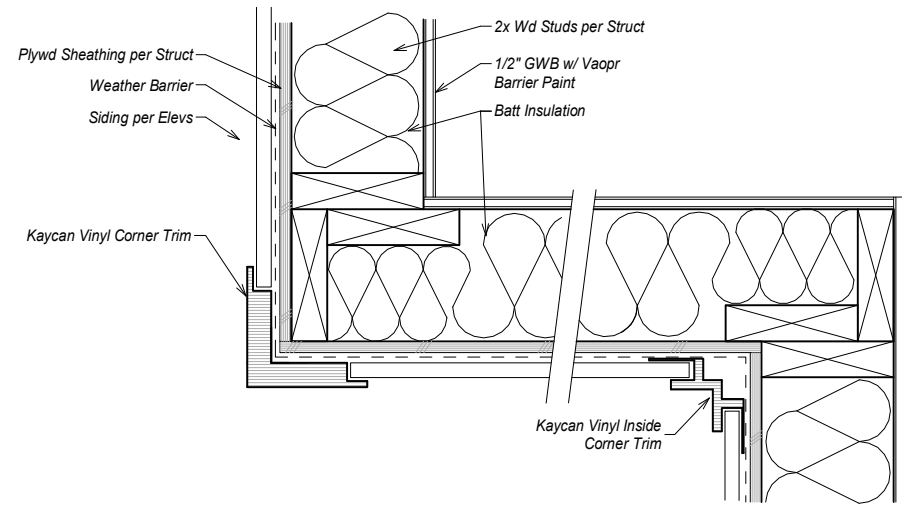
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Details


A703

SHEET:
35 of 28



1 **Typ. Corner Detail**

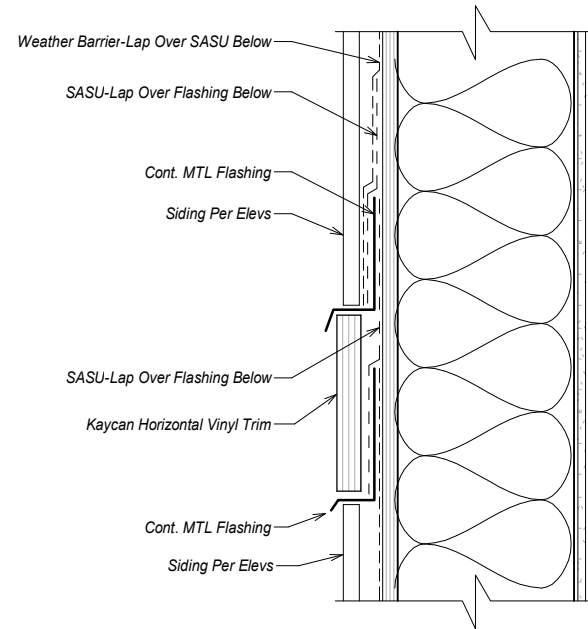1 1/2" = 1'-0"



2 **Horizontal Trim Detail**

1 : 6

REVISIONS:

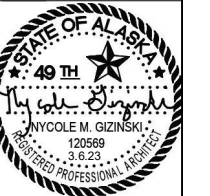
THRHA
Single Family Dwelling

STATUS:

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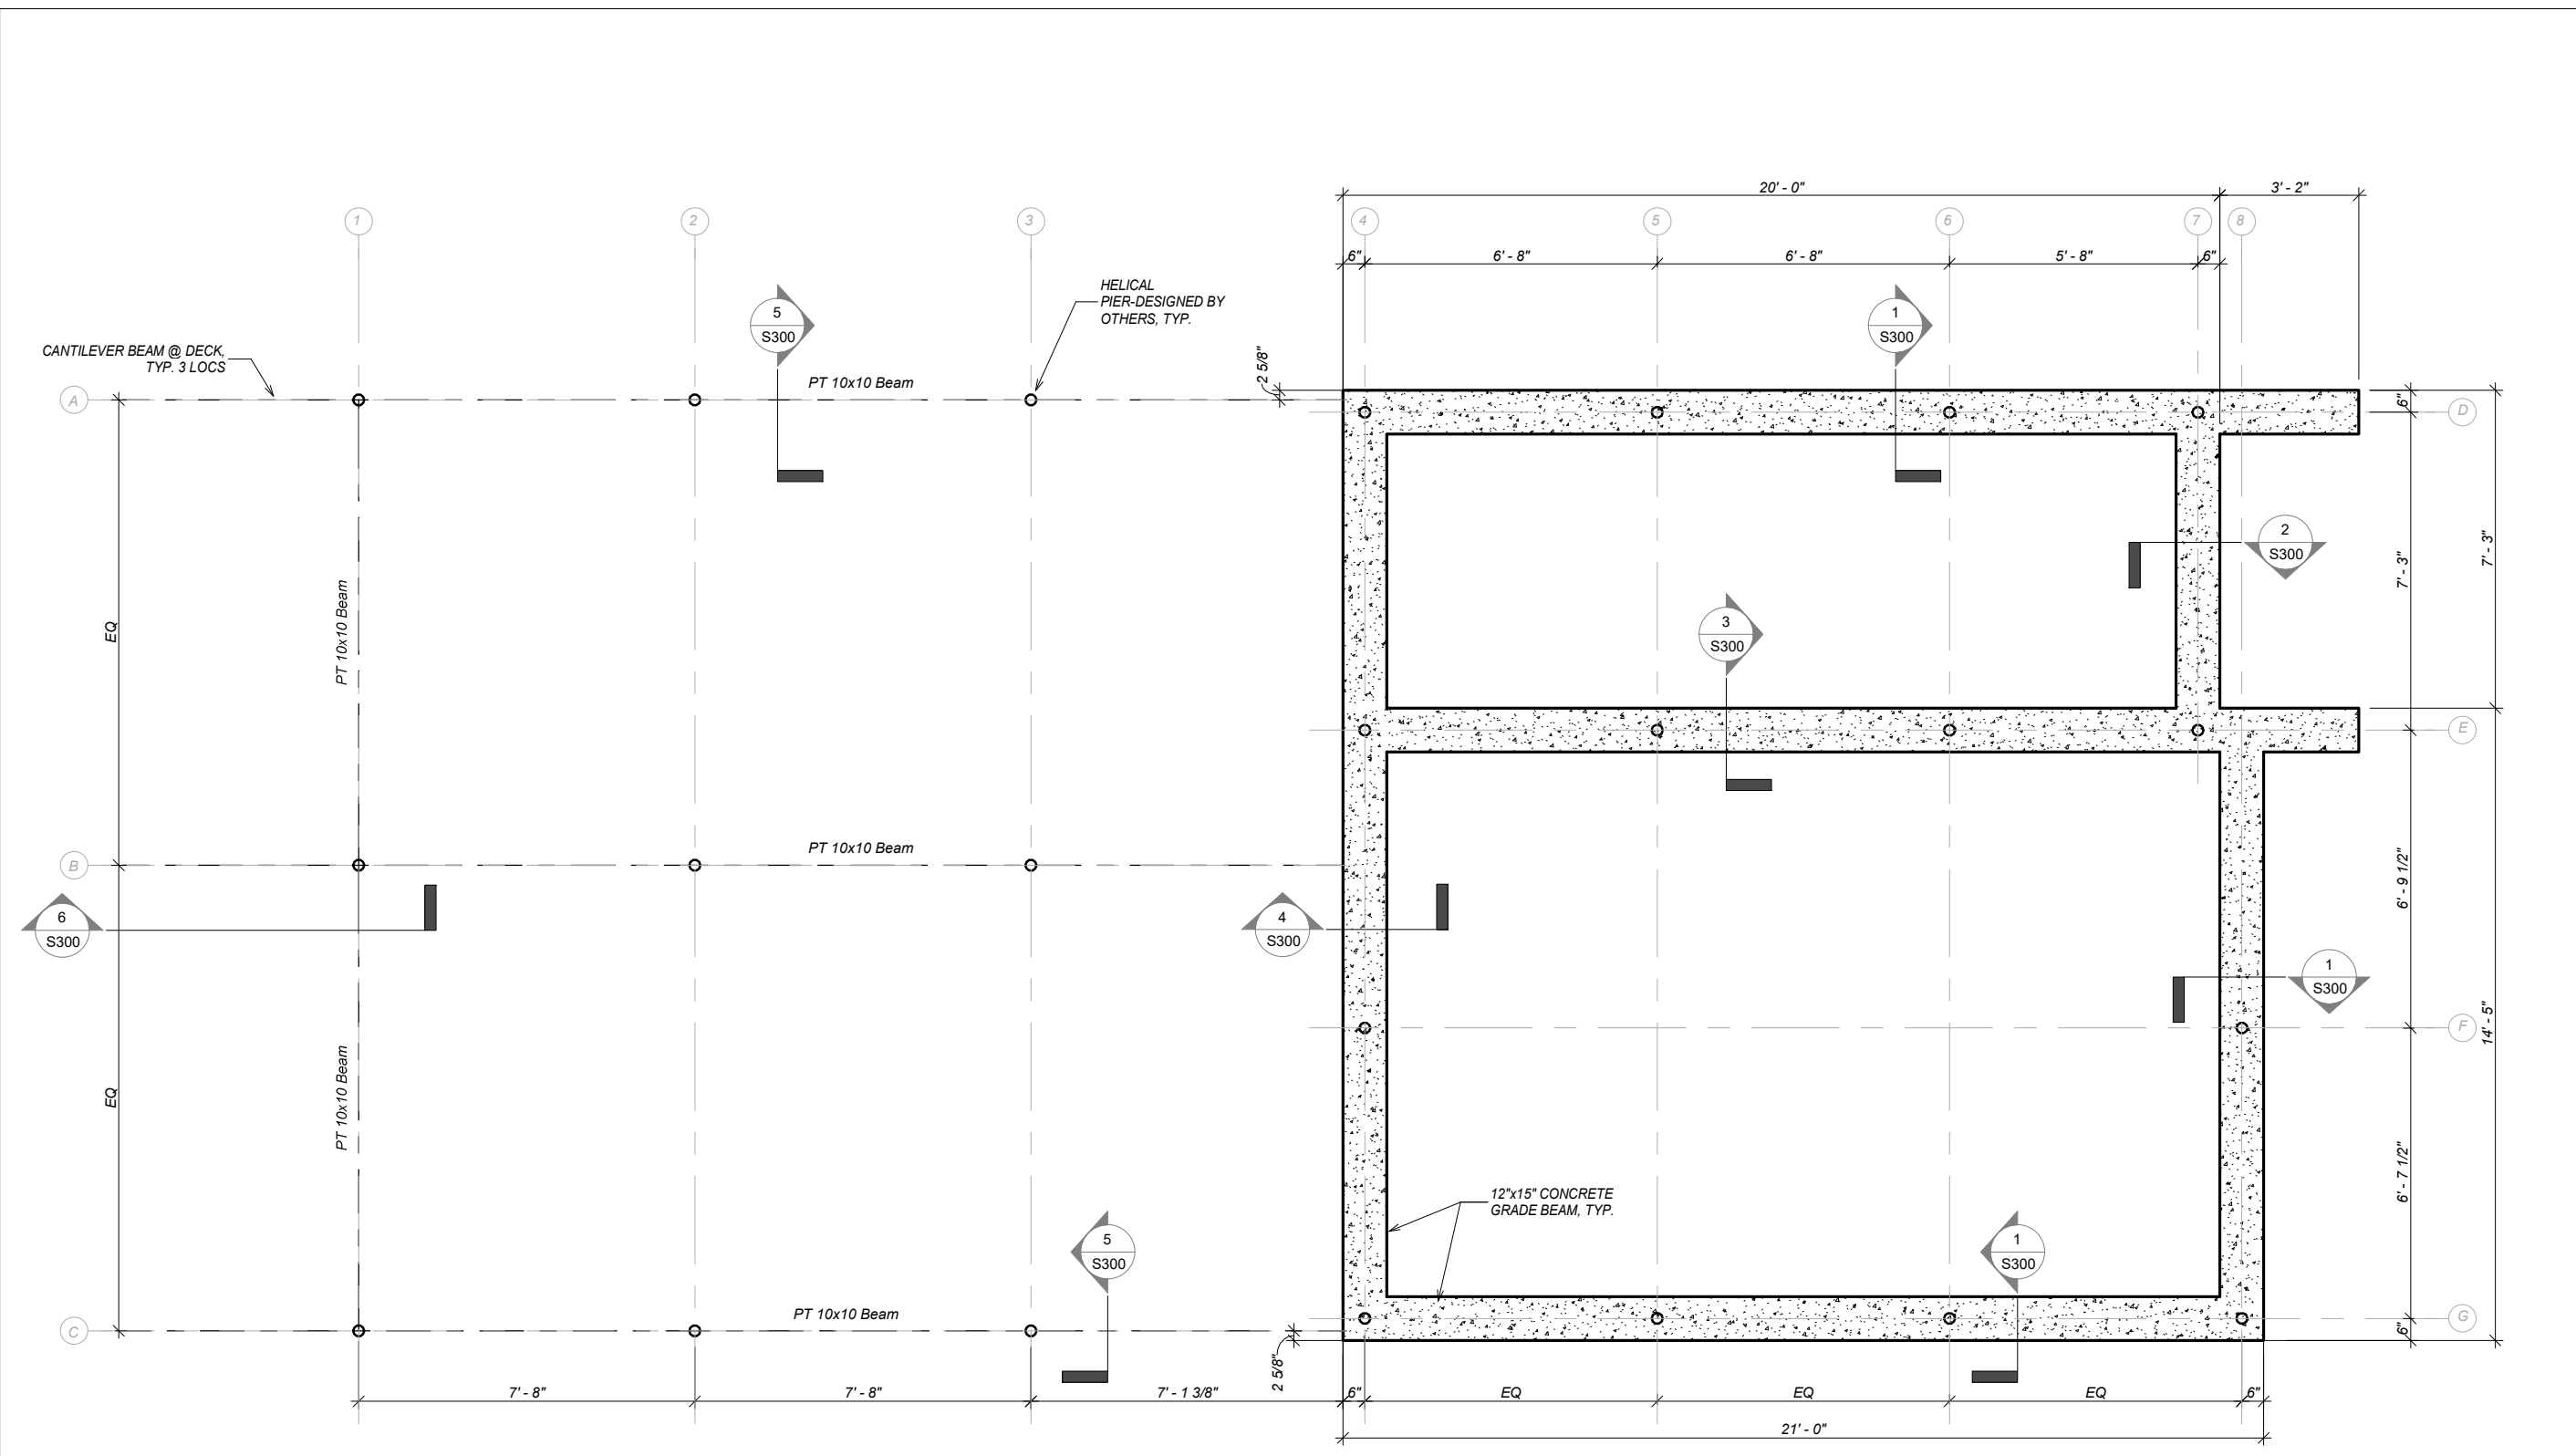
SHEET DESCRIPTION:

Details

A704

SHEET:

36 of 28



1 Foundation Plan
1/4" = 1'-0"

REVISIONS:

THRHA
Single Family Dwelling

STATUS:
CONSTRUCTION DOCUMENTS

DRAWN BY: NMG
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DATE: 3.6.23
PROJECT #: 222321.10


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SHEET DESCRIPTION:
Foundation Plan

S200

SHEET:
38 of 28



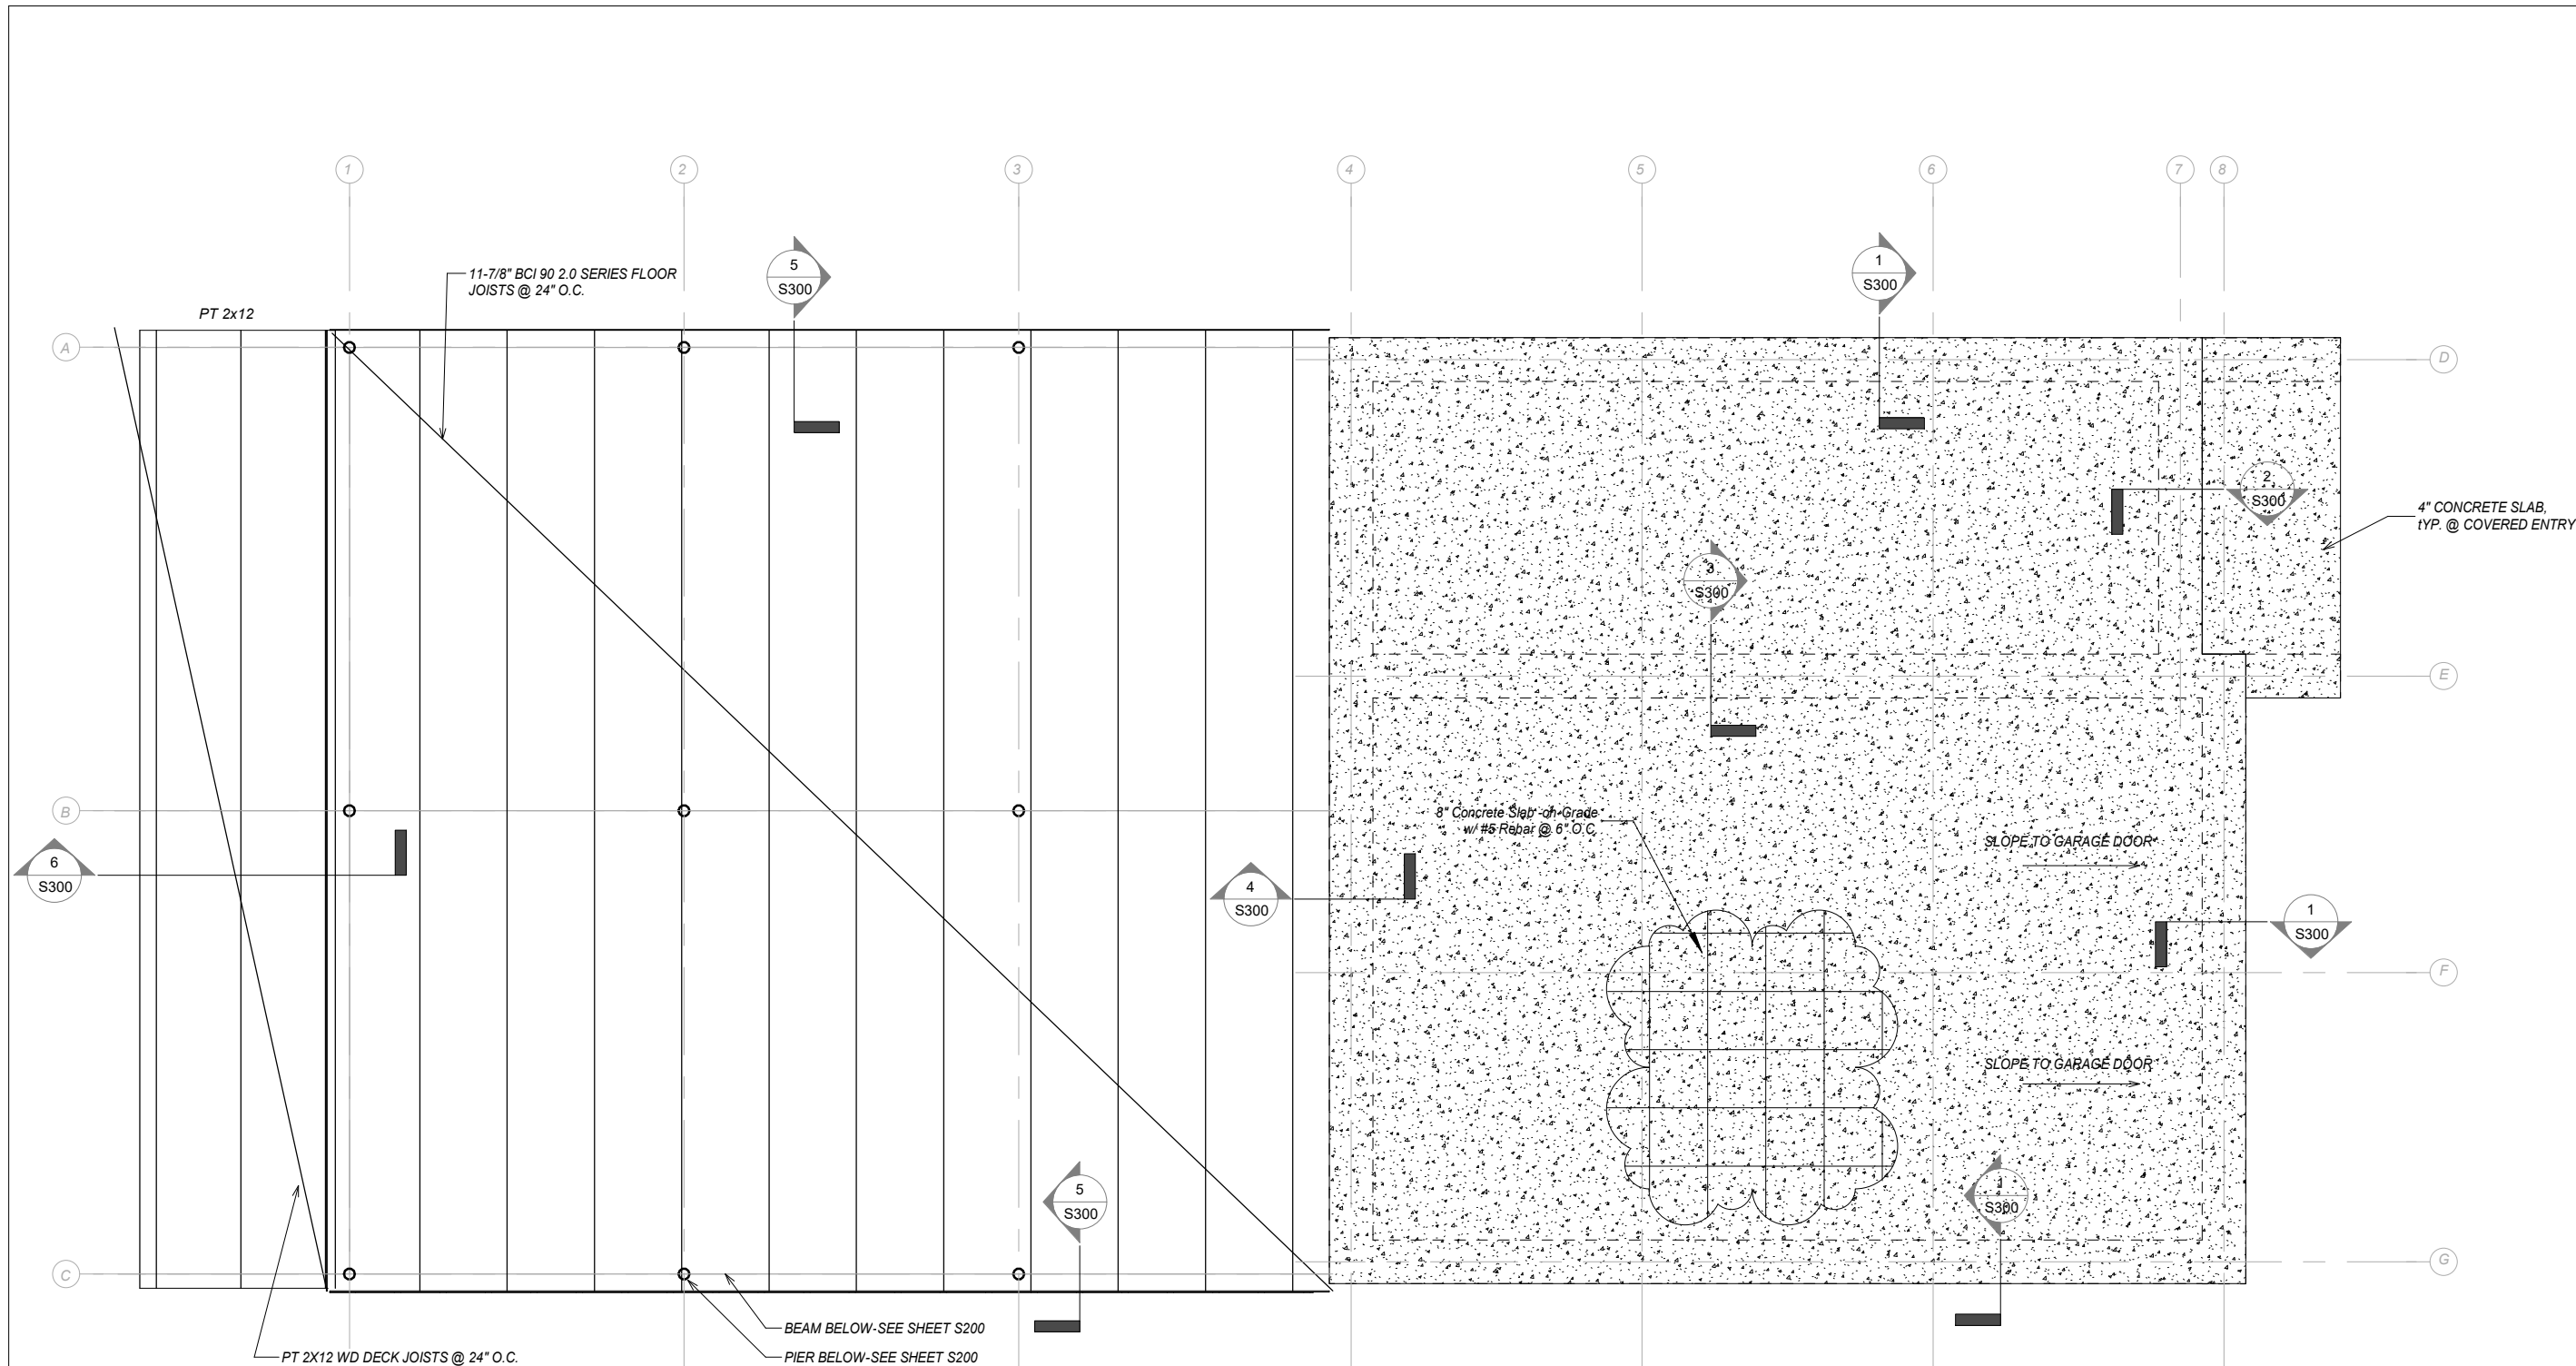1 Main Floor Framing Plan

1/4" = 1'-0"

REVISIONS:

THRHA
Single Family Dwelling

STATUS:
CONSTRUCTION DOCUMENTS

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DATE: 3.6.23
PROJECT #: 222321.10


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SHEET DESCRIPTION:
Main Floor Framing

S201

SHEET:
of 28



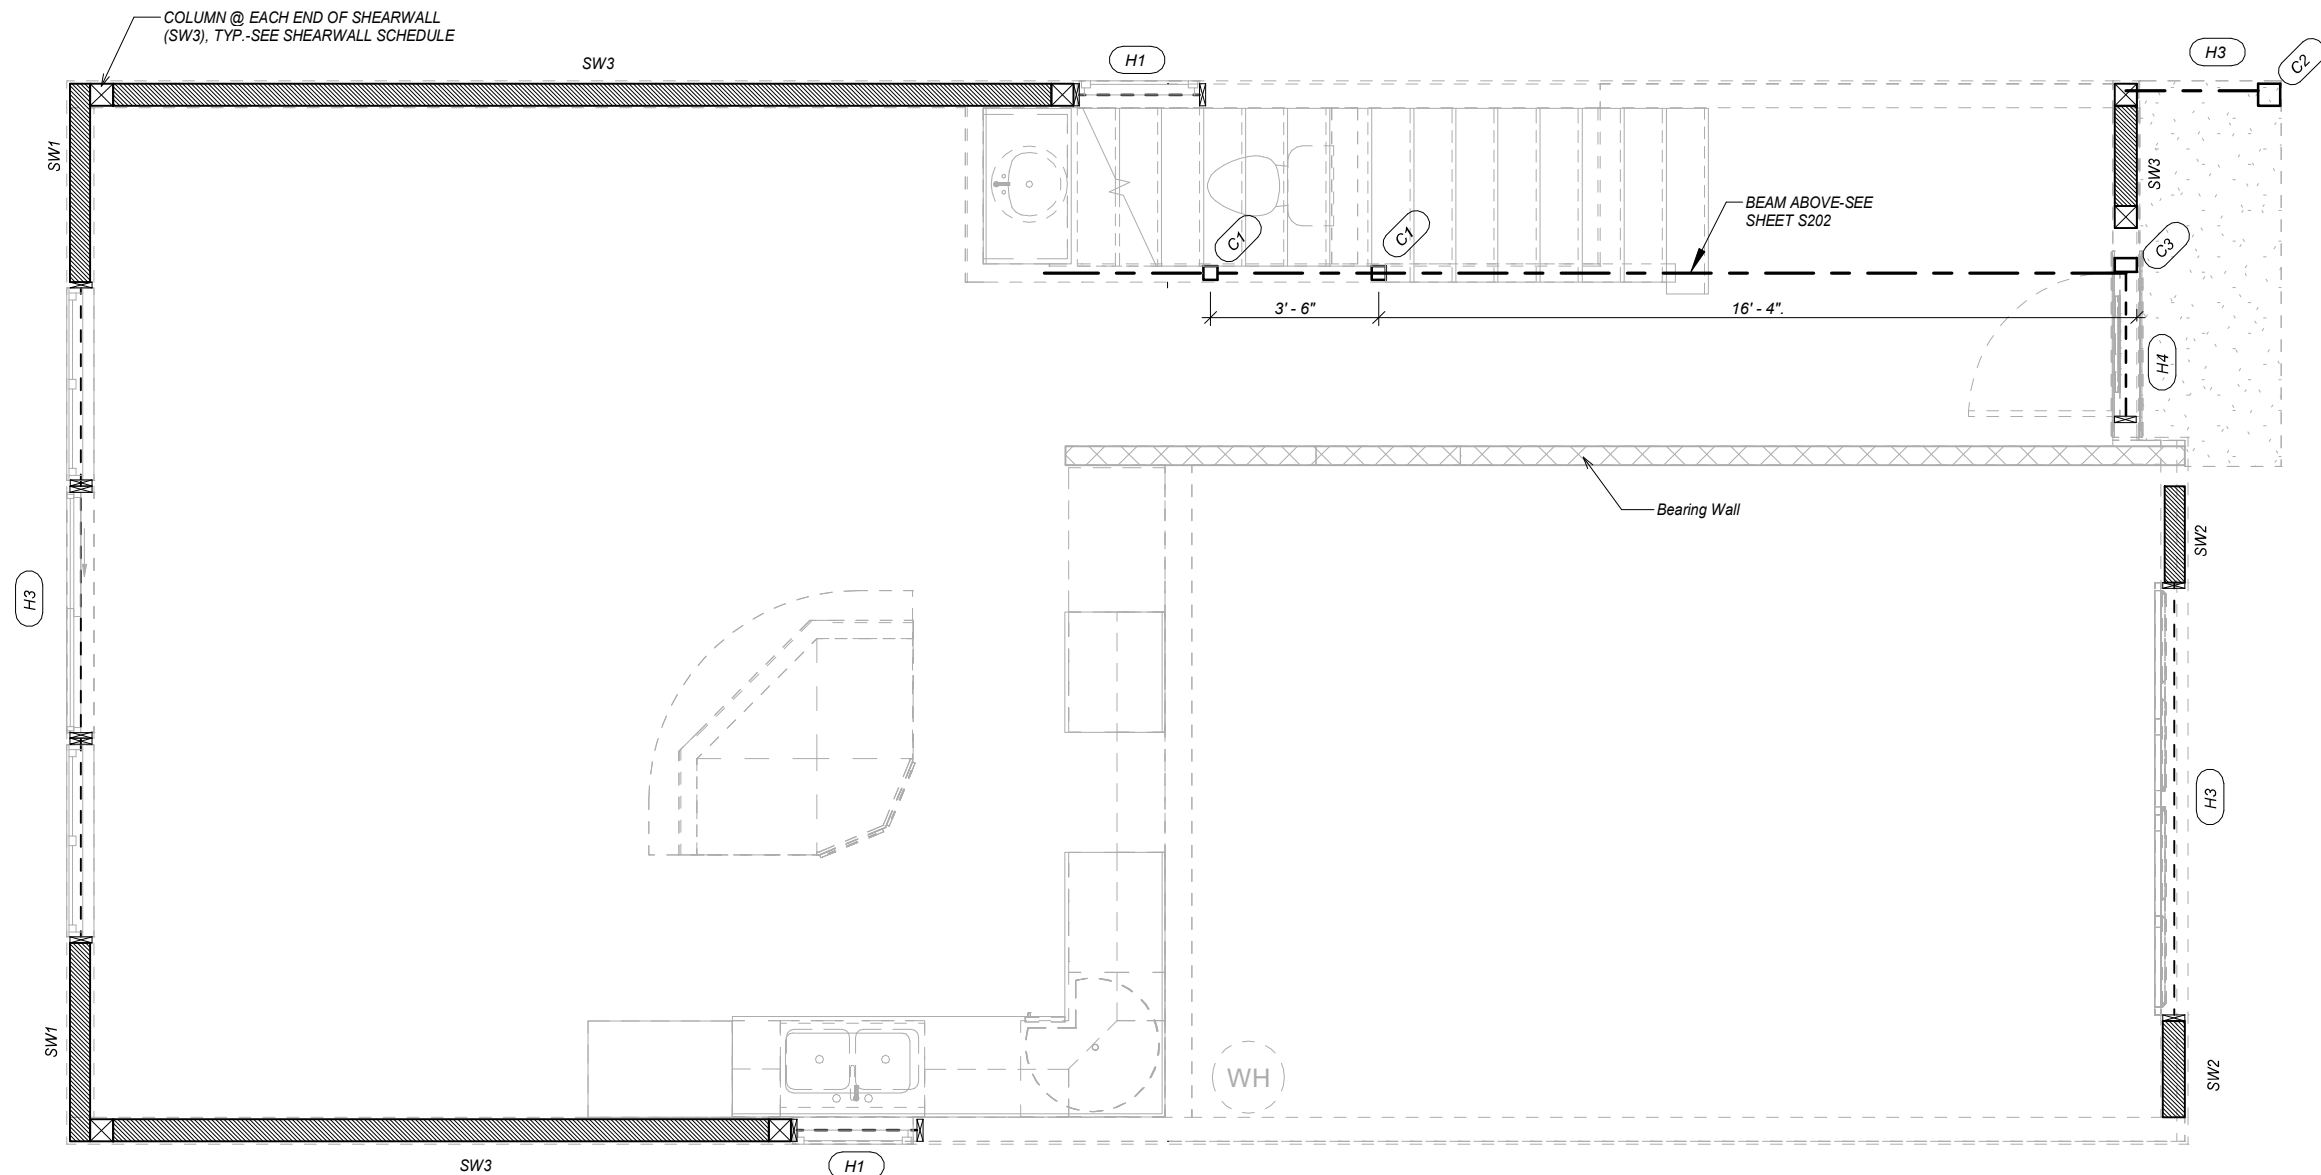1 Main Level Shearwall & Header Plan

1/4" = 1'-0"

Header Schedule

Type Mark	Type
H1	Double 2x8 Header
H2	Double 2x12 Header
H3	6x8 Header
H4	6x12

Column Schedule

Type Mark	Type
C1	Pipe3STD
C2	PT 6x6
C3	4X6

SHEARWALL SCHEDULE

- SW1 SIMPSON STRONGWALL SSW24X9
 - SW2 SIMPSON STRONG WALL SSW24x9-MAIN FLOOR ONLY
 - SW3 ALL WALLS 15/32" CDX STRUCTURAL SHEATHING ONE SIDE. FASTENERS TO BE 10d WITH 1-1/2" PENETRATION INTO FRAMING.
- BASE FLOOR** - OUTSIDE PANEL NAILING TO BE 4", INTERIOR SPACING TO BE 12". MIN 6x6 AT EACH END OR AS NOTED WITH SIMPSON HHDQ8-SDS3. SILL PLATE BOLTS TO BE 5/8" @ 24" O.C.. SILL PLATE BOLTS AT NON SHEARWALLS LOCATIONS TO BE 5/8" @ 48" O.C.
- UPPER FLOOR** - OUTSIDE PANEL NAILING TO BE 6", INTERIOR SPACING TO BE 12". 4X6 AT EACH END. FLOOR-TO-FLOOR CONNECTION TO BE SIMPSON HHDQ8 W/ 7/8" THREADED ROD. FASTEN 7/8" ROD THROUGH STRUCTURAL RIM ABOVE GARAGE DOOR @ GRID 2 WHERE STRONG WALL PANELS ARE BELOW. NOTE: SHEARWALL DETAIL IS SIMILAR AT GRID 1.

NOTES:

1. FLOOR SHEATHING SHALL BE 1 1/8" T&G APA STURDI-FLOOR, EXP. 1, STRUCTURAL 1, T&G W/ PANEL INDEX 48/24. LONG AXIS PERPENDICULAR TO JOISTS W/ TRANSVERSE JOISTS STAGGERED.
2. BEARING WALLS SHALL BE 2"x6" LUMBER BEAMS, SET @ 16" O.C., UNLESS OTHERWISE NOTED.
3. INTERIOR WALL SHALL BE 2"x4" LUMBER BEAMS, SET AT 16" O.C., UNLESS OTHERWISE NOTED.
4. FLOOR TO FLOOR STRAPPING TO BE SIMPSON CMST12, CLEAR SPAN +90°, ON 8' CENTERS ALONG THE EXTERIOR WALLS.
5. ALL BEAMS MUST HAVE MINIMUM BEARING LENGTH OF 3"
6. INTERIOR HEADERS LOCATED W/IN A NON-BEARING WALL SHALL CONSIST OF A (2) 2x8 HEADER SUPPORTED BY A (1) 2x (MIN.) JACK STUD @ BOTH ENDS.
7. CONTRACTOR TO VERIFY HANGER DIMENSION AND CONFIGURATIONS WITH SIMPSON PRIOR TO CONSTRUCTION. ADDITIONALLY, ALL JOIST HANGERS AND BEAM SUPPORTS SHALL BE APPROVED BY THE DESIGN ENGINEER PRIOR TO CONSTRUCTION.


REVISIONS:

THRHA
Single Family Dwelling

STATUS:
CONSTRUCTION DOCUMENTS

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DATE: 3.6.23
PROJECT #: 222321.10


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SHEET DESCRIPTION:
Main Floor Header & Shearwall Plan

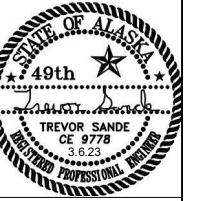S202

SHEET:
40 of 28



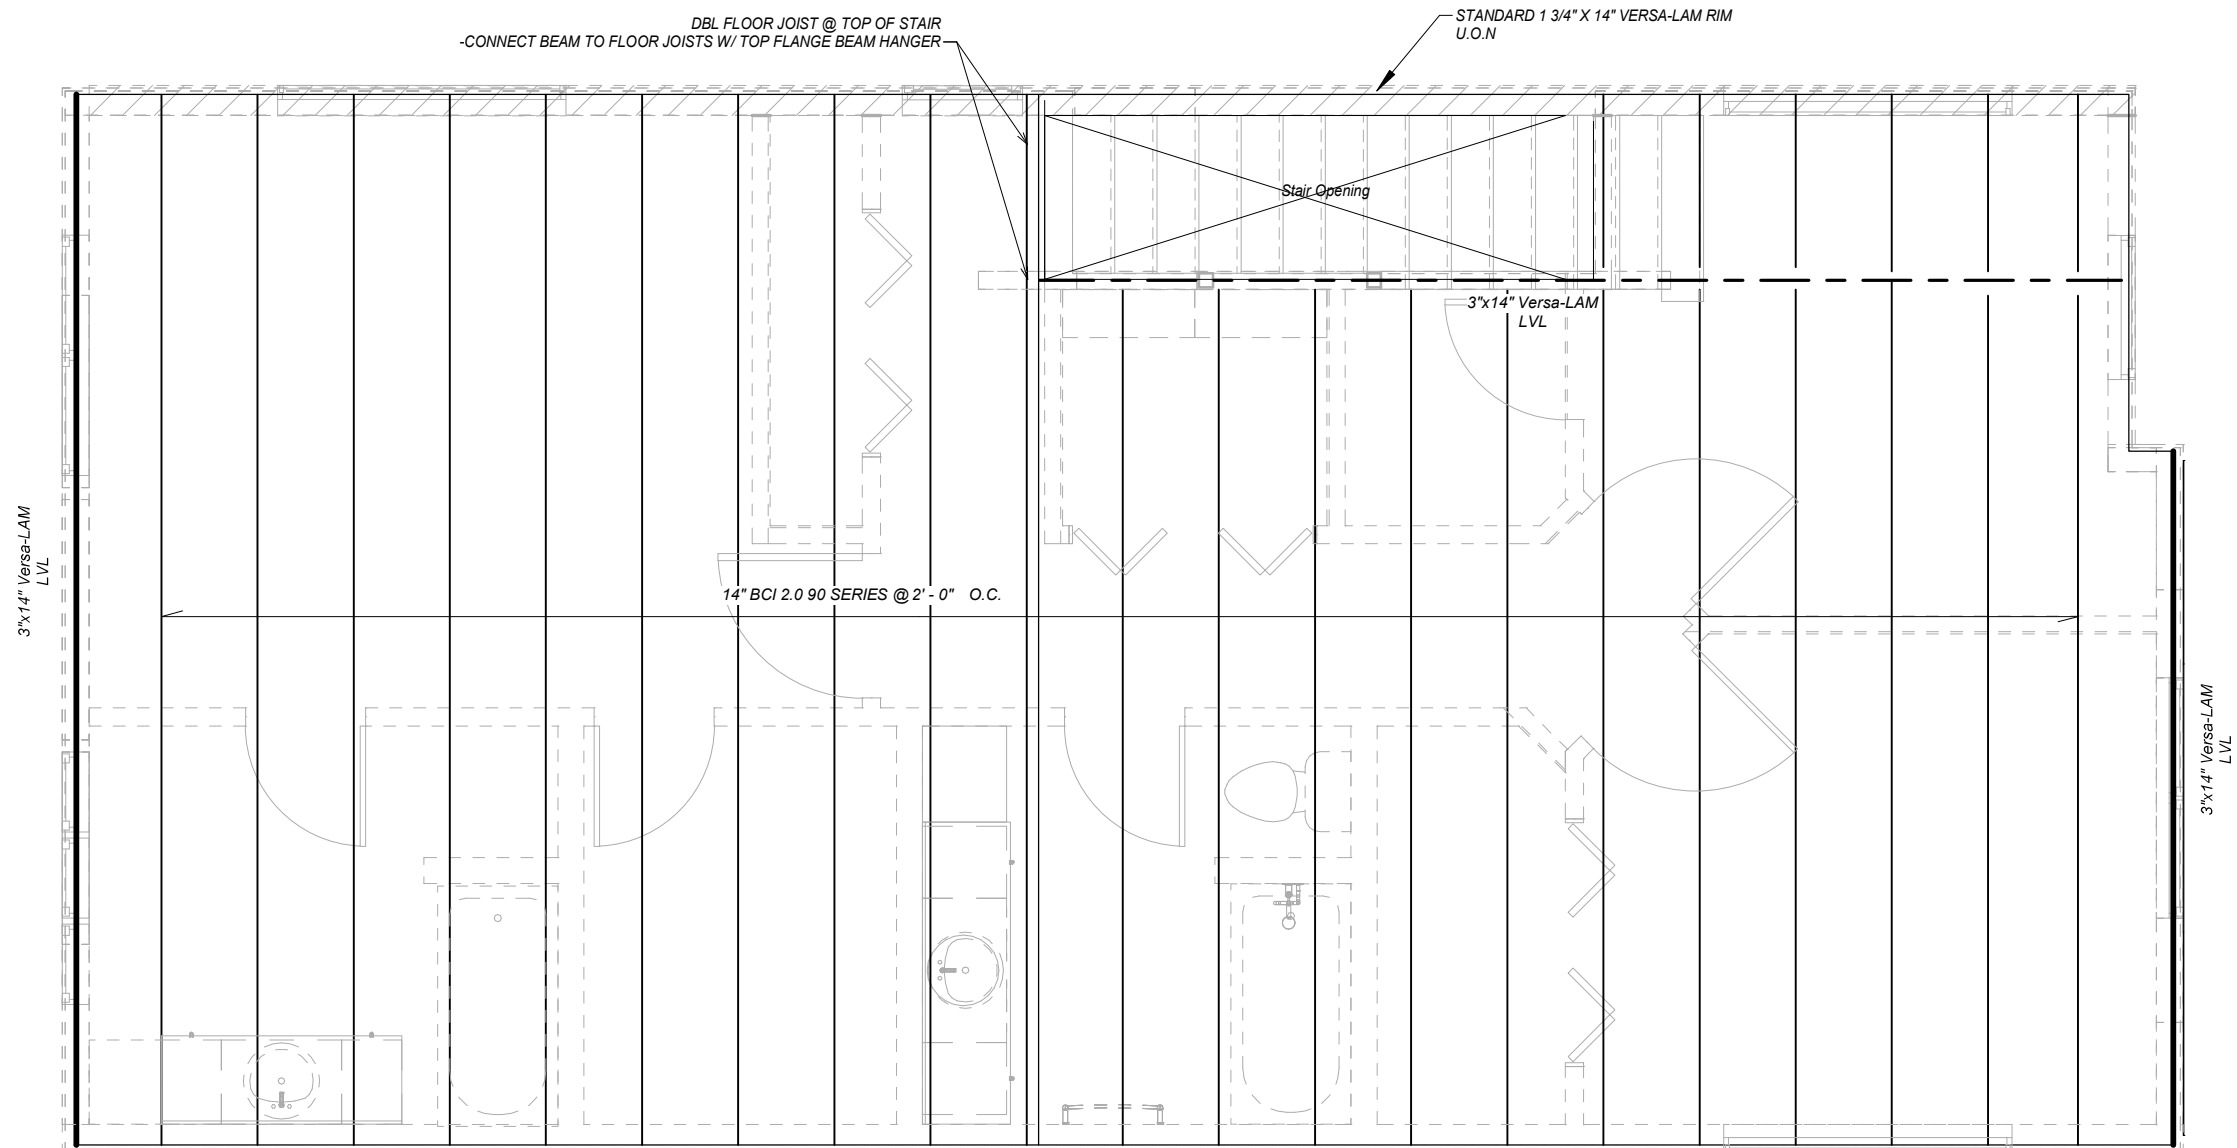1 Upper Floor Framing Plan
1/4" = 1'-0"

REVISIONS:

THRHA
Single Family Dwelling

STATUS:
CONSTRUCTION DOCUMENTS

DRAWN BY: NMG
CHECKED BY: TSS
DATE: 3.6.23
PROJECT #: 222321.10


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SHEET DESCRIPTION:
Upper Floor Framing Plan

S203

SHEET:
39 of 28



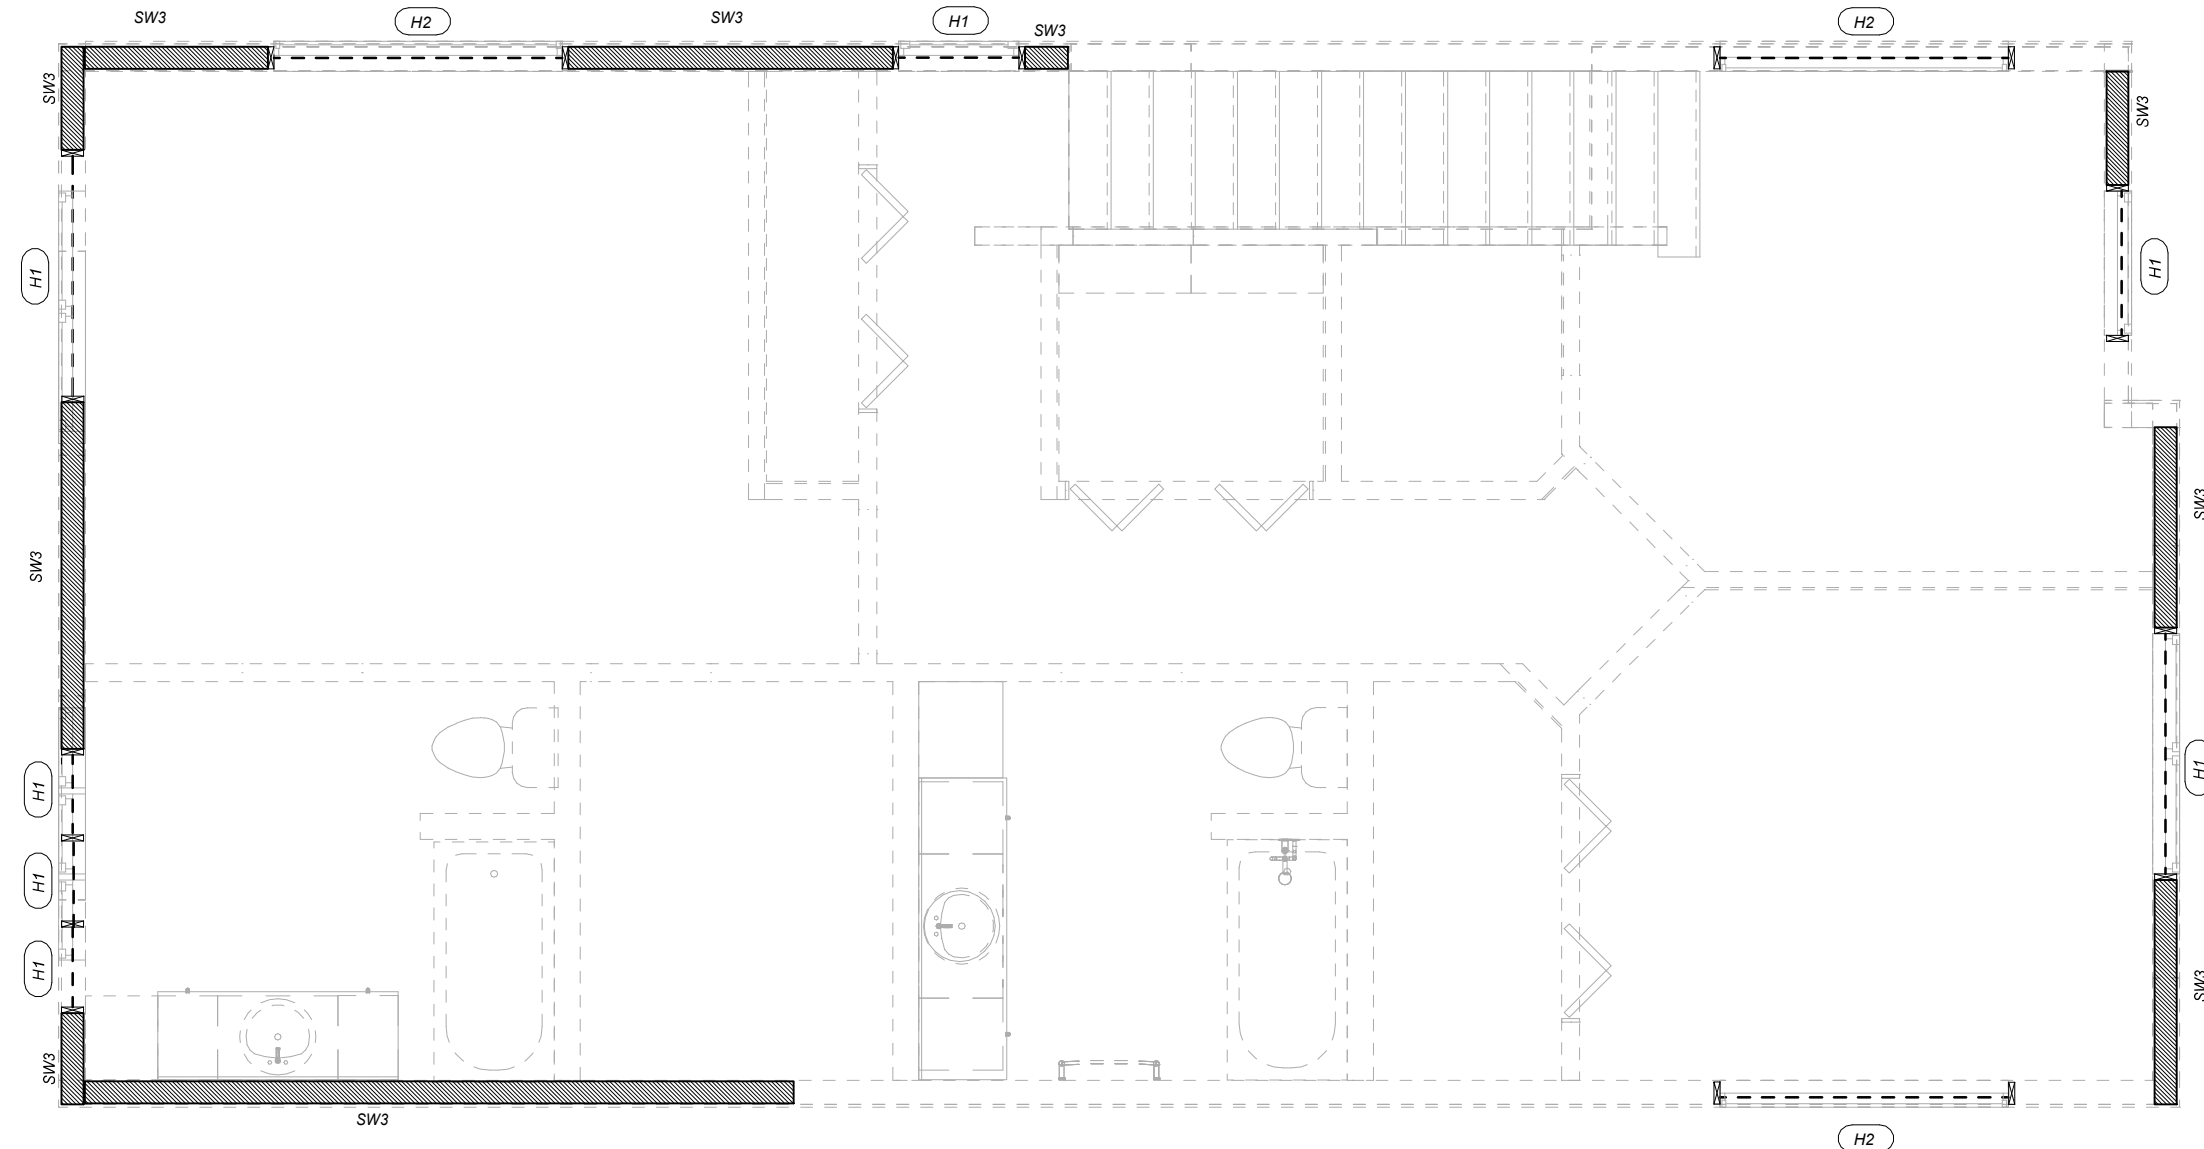1 Upper Level Shearwall & Header Plan
1/4" = 1'-0"

Header Schedule	
Type Mark	Type
H1	Double 2x8 Header
H2	Double 2x12 Header
H3	6x8 Header
H4	6x12

Column Schedule	
Type Mark	Type
C1	Pipe3STD
C2	PT 6x6
C3	4X6

SHEARWALL SCHEDULE

- SW1 SIMPSON STRONGWALL SSW24X9
- SW2 SIMPSON STRONG WALL SSW24x9-MAIN FLOOR ONLY
- SW3 ALL WALLS 15/32" CDX STRUCTURAL SHEATHING ONE SIDE. FASTENERS TO BE 10d WITH 1-1/2" PENETRATION INTO FRAMING.

BASE FLOOR - OUTSIDE PANEL NAILING TO BE 4", INTERIOR SPACING TO BE 12". MIN 6x6 AT EACH END OR AS NOTED WITH SIMPSON HHdq8-SDS3. SILL PLATE BOLTS TO BE 5/8" @ 24" O.C., SILL PLATE BOLTS AT NON SHEARWALLS LOCATIONS TO BE 5/8" @ 48" O.C.

UPPER FLOOR - OUTSIDE PANEL NAILING TO BE 6", INTERIOR SPACING TO BE 12". 4X6 AT EACH END. FLOOR-TO-FLOOR CONNECTION TO BE SIMPSON HHdq8 W/ 7/8" THREADED ROD. FASTEN 7/8" ROD THROUGH STRUCTURAL RIM ABOVE GARAGE DOOR @ GRID 2 WHERE STRONG WALL PANELS ARE BELOW.
NOTE: SHEARWALL DETAIL IS SIMILAR AT GRID 1.

NOTES:

1. FLOOR SHEATHING SHALL BE 1 1/8" T&G APA STURDI-FLOOR, EXP. 1, STRUCTURAL 1, T&G W/ PANEL INDEX 48/24. LONG AXIS PERPENDICULAR TO JOISTS W/ TRANSVERSE JOISTS STAGGERED.
2. BEARING WALLS SHALL BE 2"x6" LUMBER BEAMS, SET @ 16" O.C., UNLESS OTHERWISE NOTED.
3. INTERIOR WALL SHALL BE 2"x4" LUMBER BEAMS, SET AT 16" O.C., UNLESS OTHERWISE NOTED.
4. FLOOR TO FLOOR STRAPPING TO BE SIMPSON CMST12, CLEAR SPAN +90°, ON 8" CENTERS ALONG THE EXTERIOR WALLS.
5. ALL BEAMS MUST HAVE MINIMUM BEARING LENGTH OF 3"
6. INTERIOR HEADERS LOCATED W/IN A NON-BEARING WALL SHALL CONSISTS OF A (2) 2x8 HEADER SUPPORTED BY A (1) 2x (MIN.) JACK STUD @ BOTH ENDS.
7. CONTRACTOR TO VERIFY HANGER DIMENSION AND CONFIGURATIONS WITH SIMPSON PRIOR TO CONSTRUCTION. ADDITIONALLY, ALL JOIST HANGERS AND BEAM SUPPORTS SHALL BE APPROVED BY THE DESIGN ENGINEER PRIOR TO CONSTRUCTION.

REVISIONS:

THRHA
Single Family Dwelling

STATUS:
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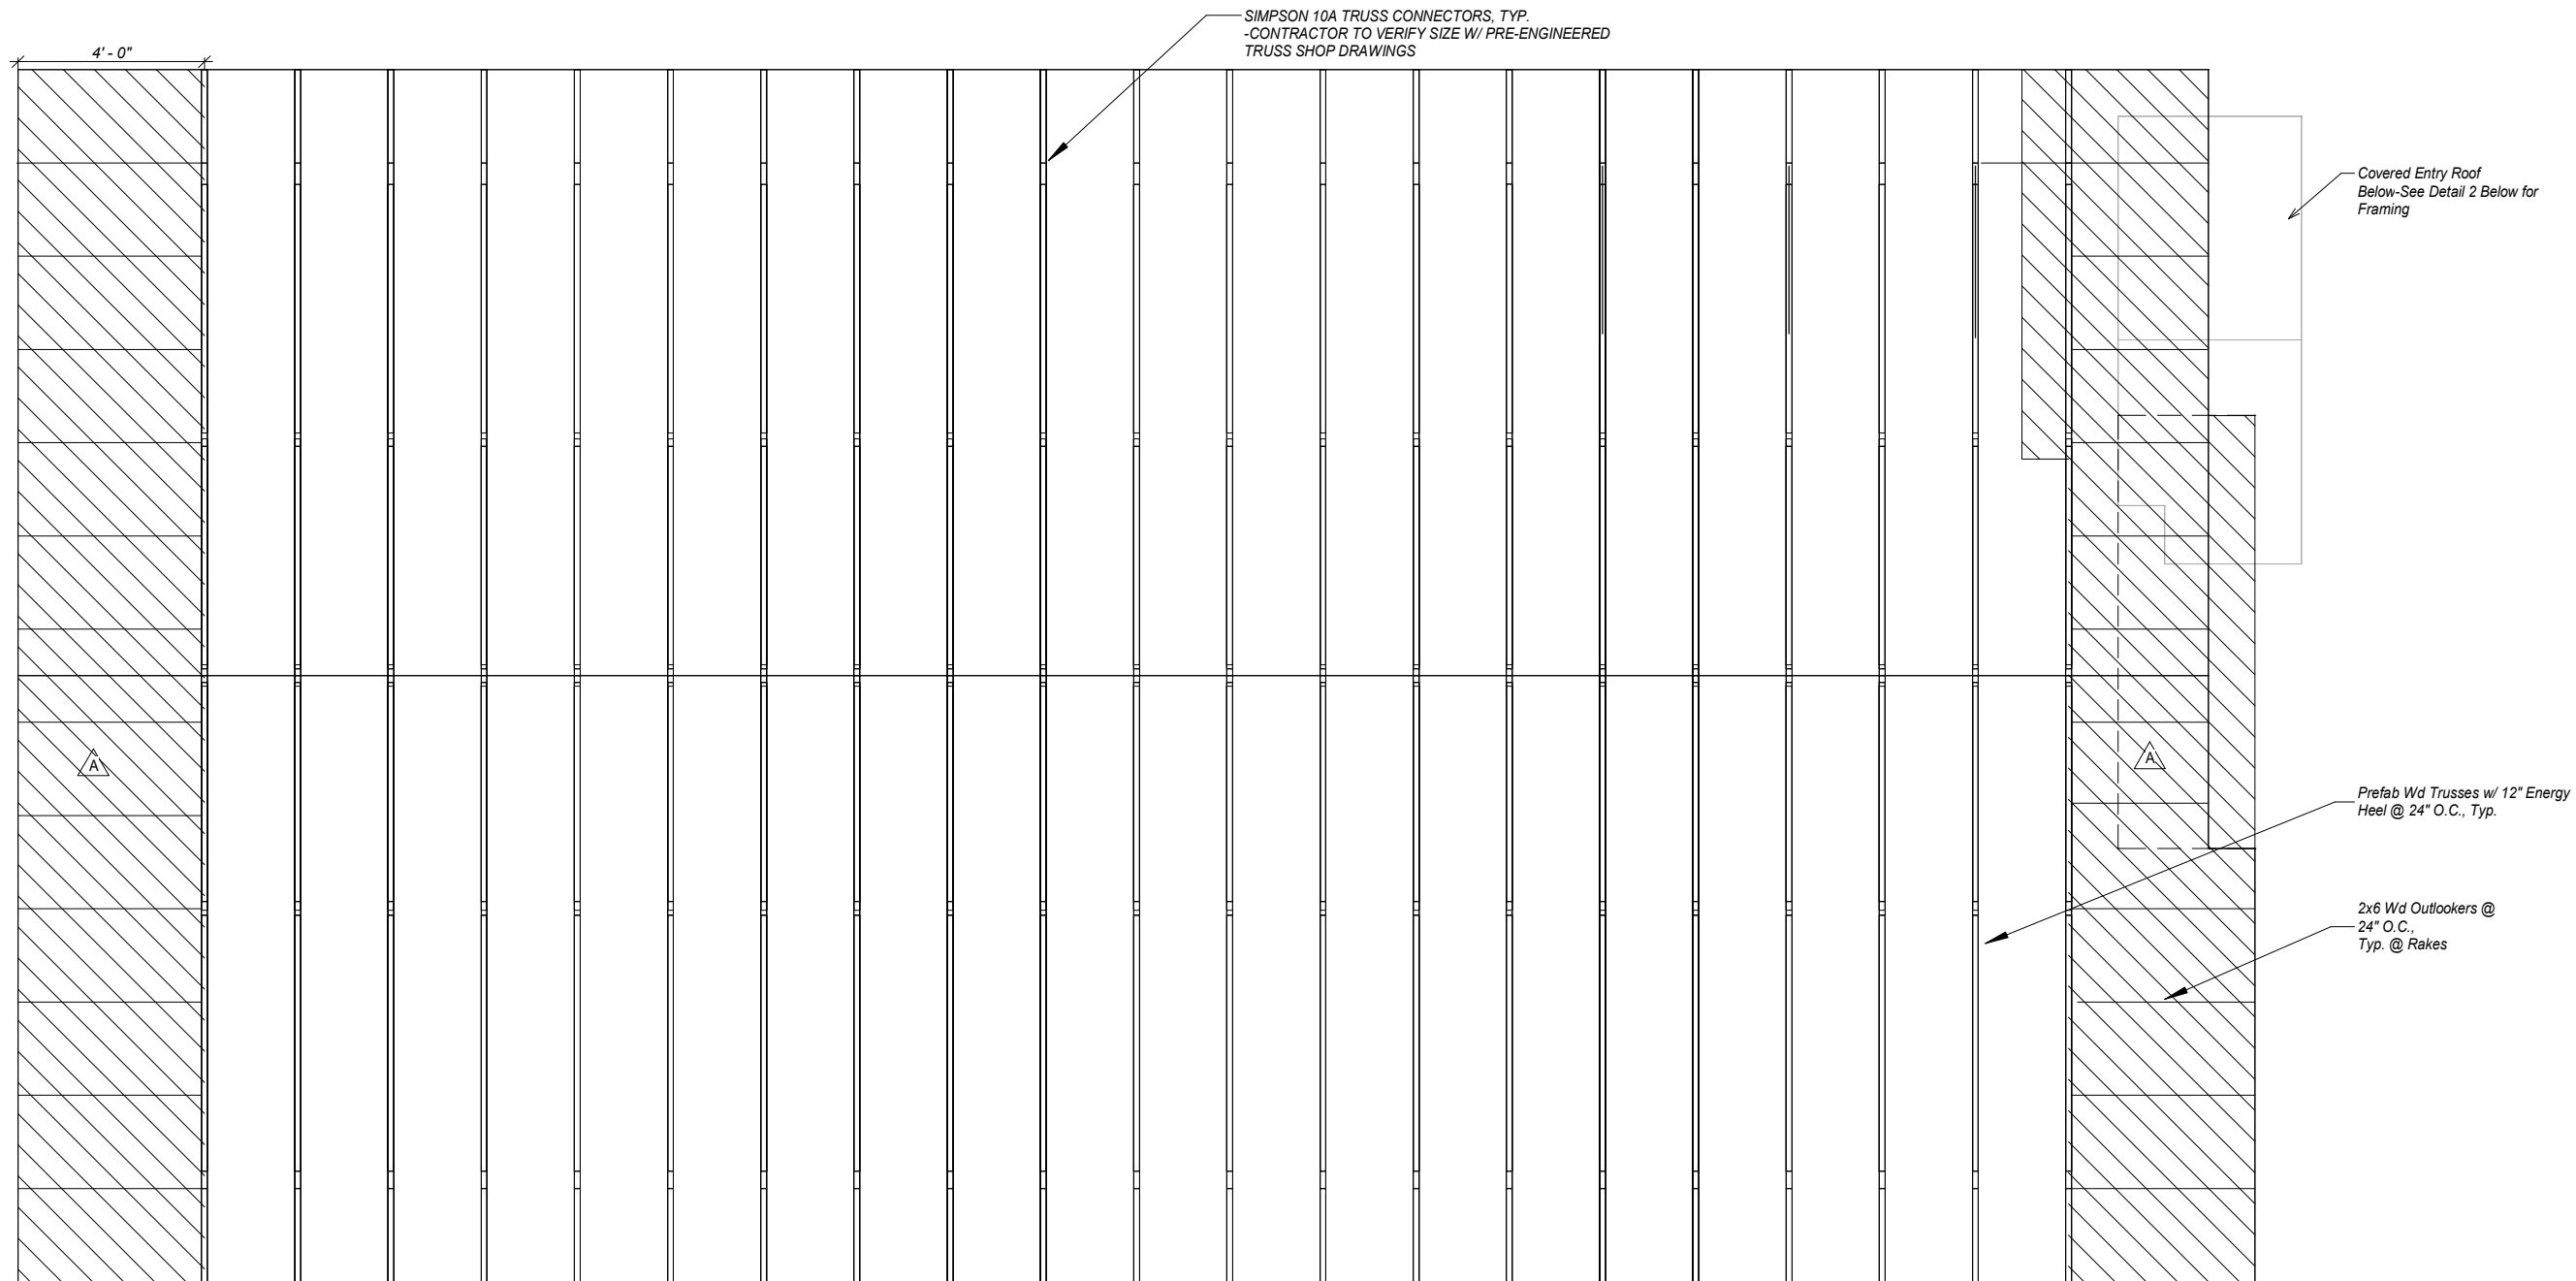
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SHEET DESCRIPTION:
Upper Level Shearwall & Header Plan

S204

SHEET:
41 of 28




1 Roof Plan
1/4" = 1'-0"

ROOF SHEATHING	
19/32" APA CDX RATED SHEATHING w/ PANEL INDEX 40/20, EXTERIOR GLUE. LONG AXIS PERPENDICULAR TO TRUSSES w/ TRANSVERSE JOINTS STAGGERED.	

DIAPHRAM SCHEDULE			
MARK	BOUNDARY NAILING	PANEL EDGE NAILING	FIELD NAILING
△	6"	6"	10"

- DIAPHRAM NOTES:**
- EXCEPT AS NOTED OTHERWISE, DIAPHRAGMS ARE UNBLOCKED.
 - ALL NAILS ARE TO BE 10d COMMON OR GALVANIZED BOX NAILS.
 - NAILS AT 6" O.C. AT SUPPORTED EDGES, 10d @ 10" O.C. IN THE FIELD, UNO.
 - AREAS DENOTED △ ARE TO BE BLOCKED AT ALL PANEL EDGES w/ FLAT 2X6.

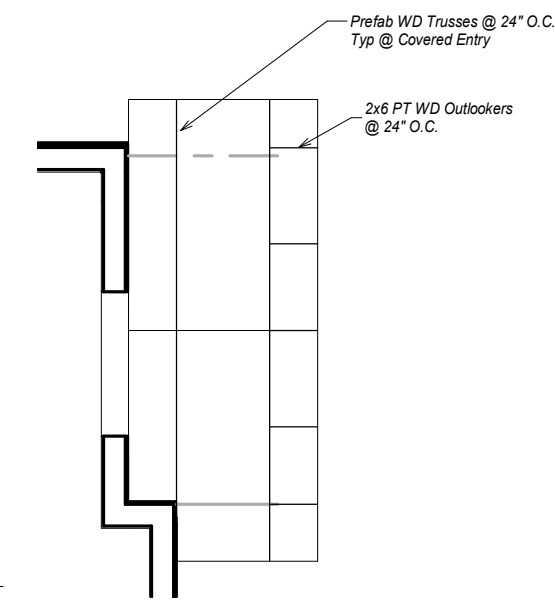2 Roof Framing Plan @ Covered Entry
1/4" = 1'-0"



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REV #	DATE
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Single Family Dwelling

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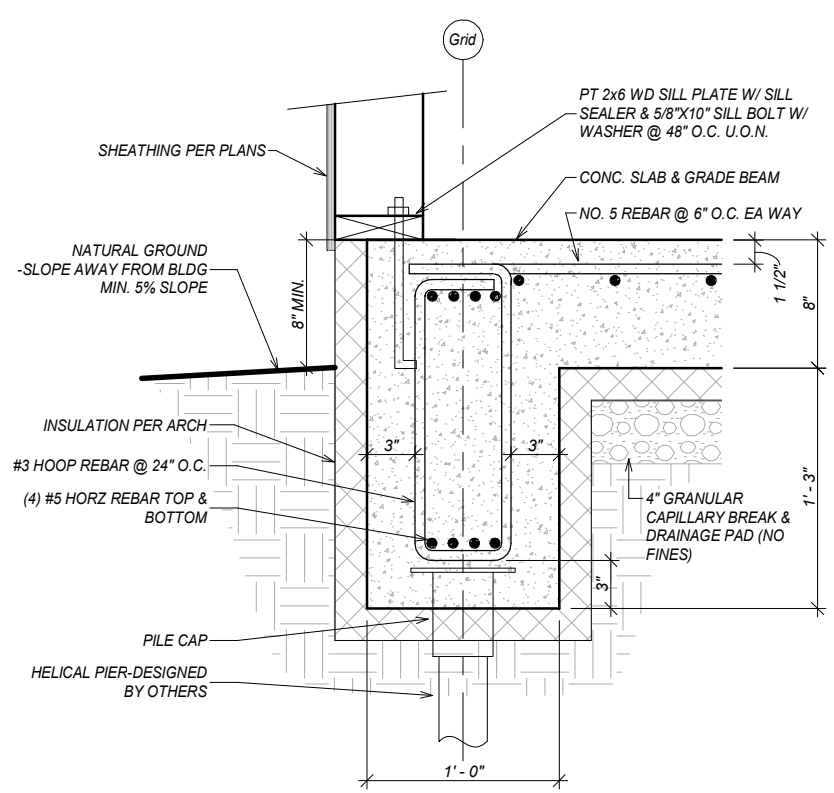
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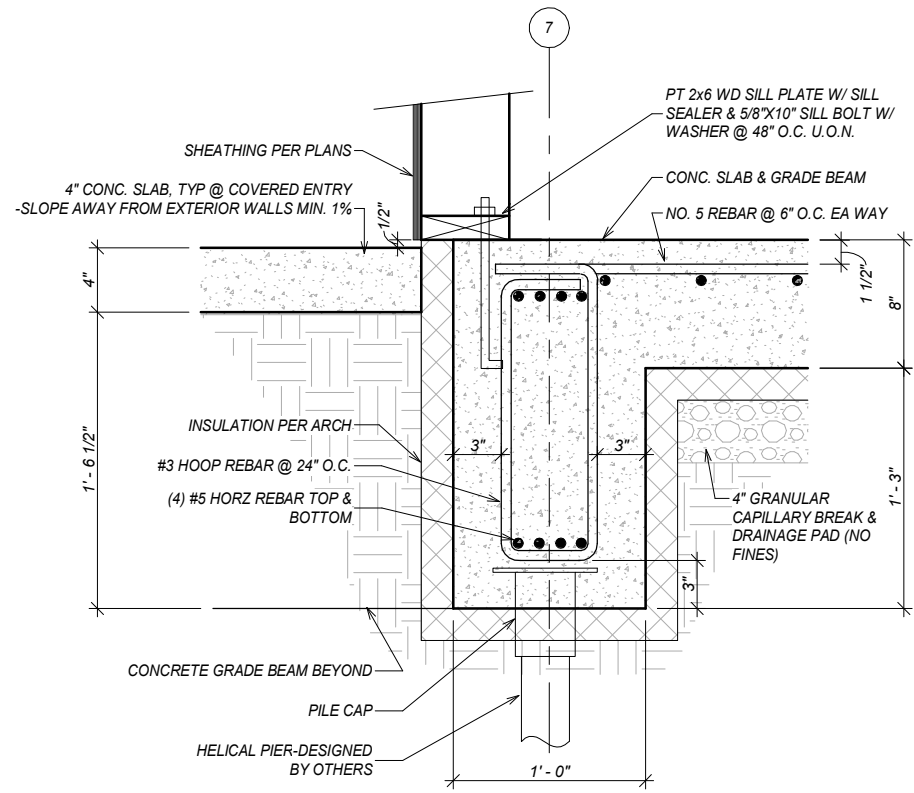
SHEET DESCRIPTION:
Roof Framing Plan

S205

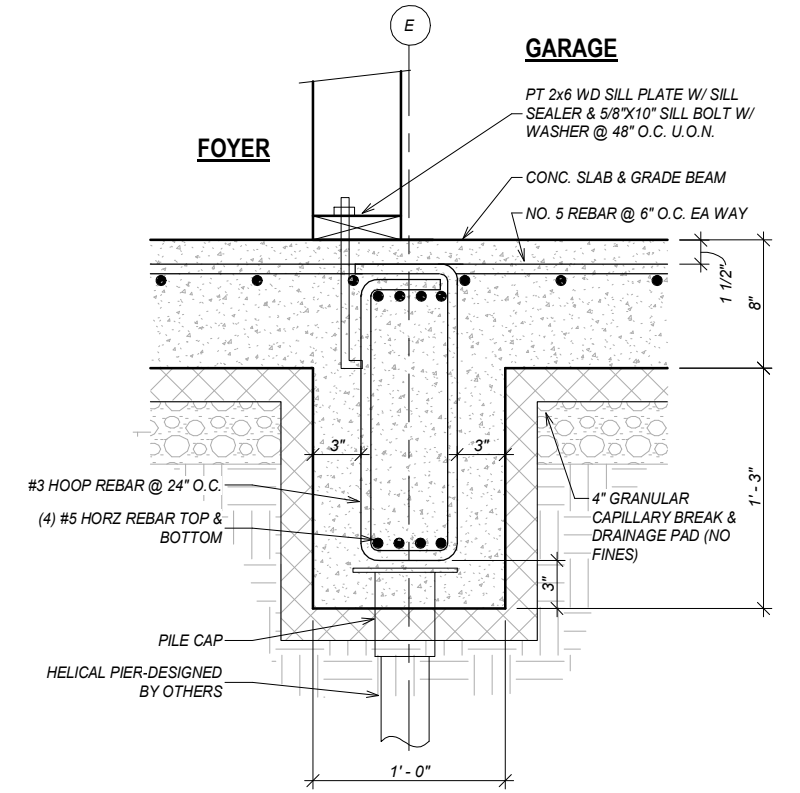
SHEET:
42 of 28




1 Typ. Grade Beam
1" = 1'-0"




2 Grade Beam @ Covered Entry
1" = 1'-0"




3 Grade Beam @ Grid E
1" = 1'-0"

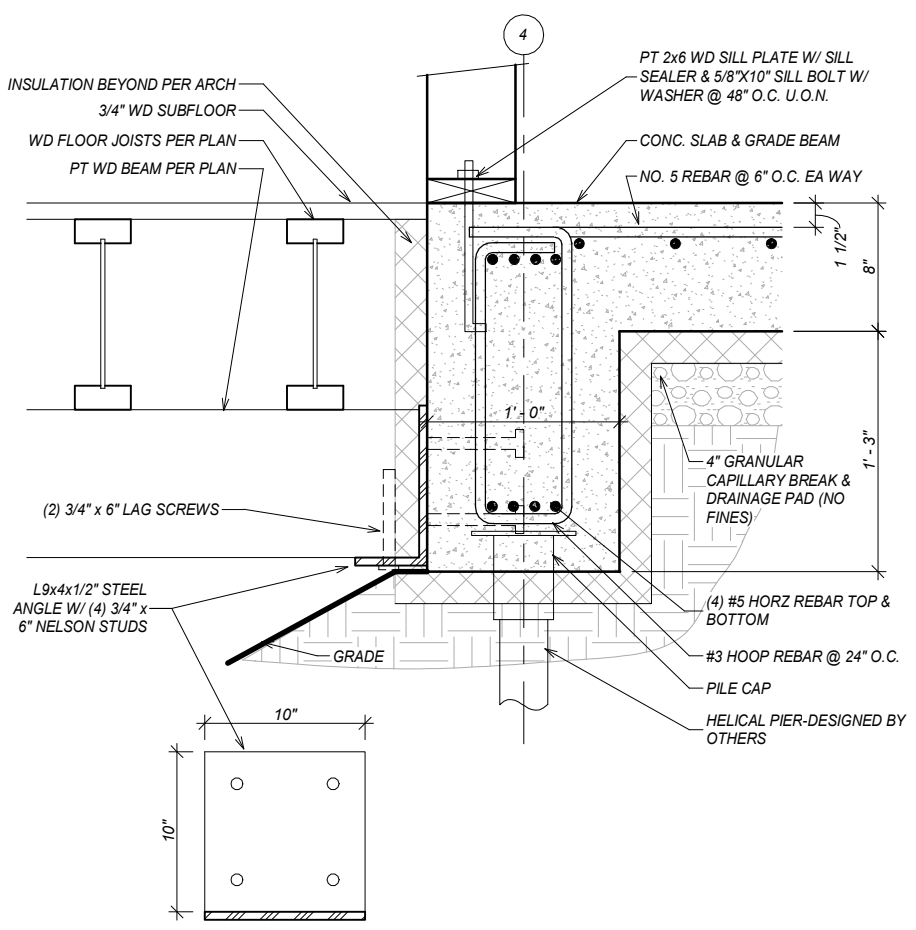

4 Grade Beam @ Grid 4
1" = 1'-0"

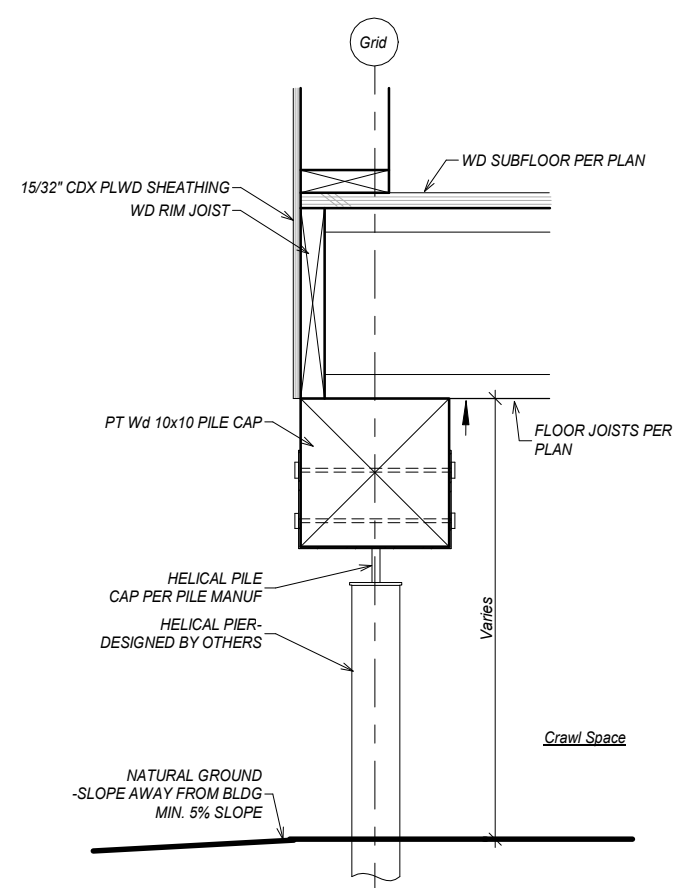

5 Typ. Perimeter Beam
1" = 1'-0"

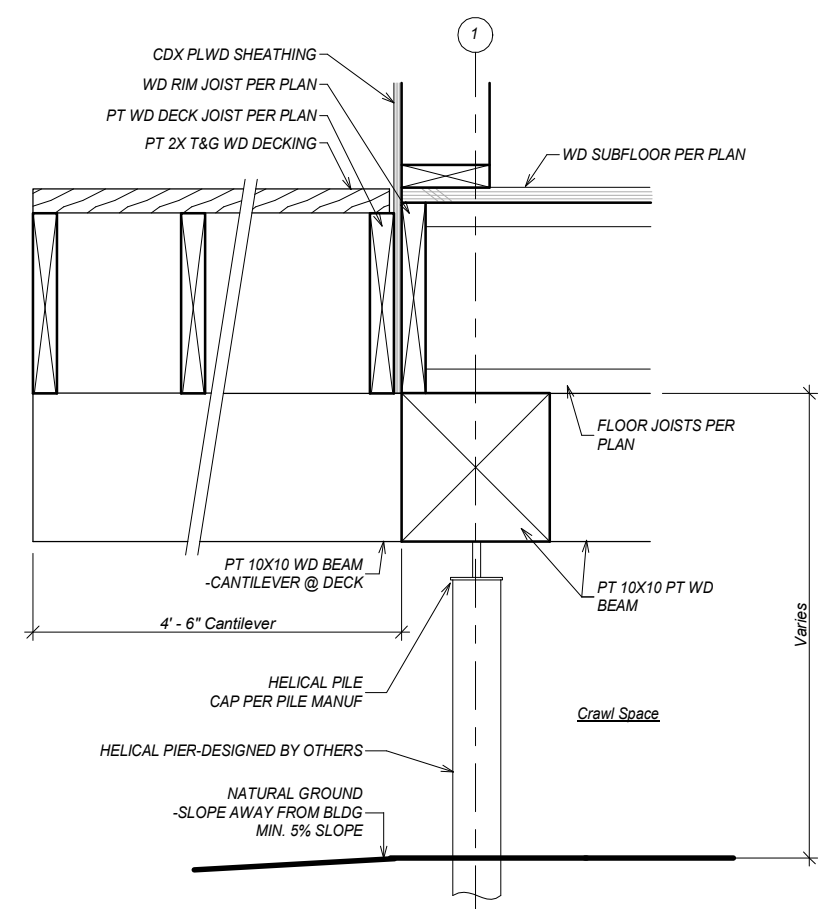

6 Typ. Beam @ Deck
1" = 1'-0"

REVISIONS:

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Single Family Dwelling

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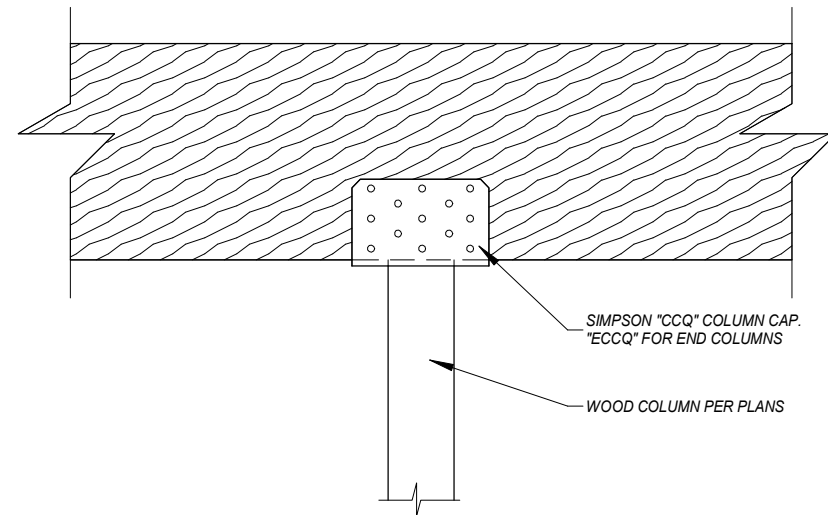
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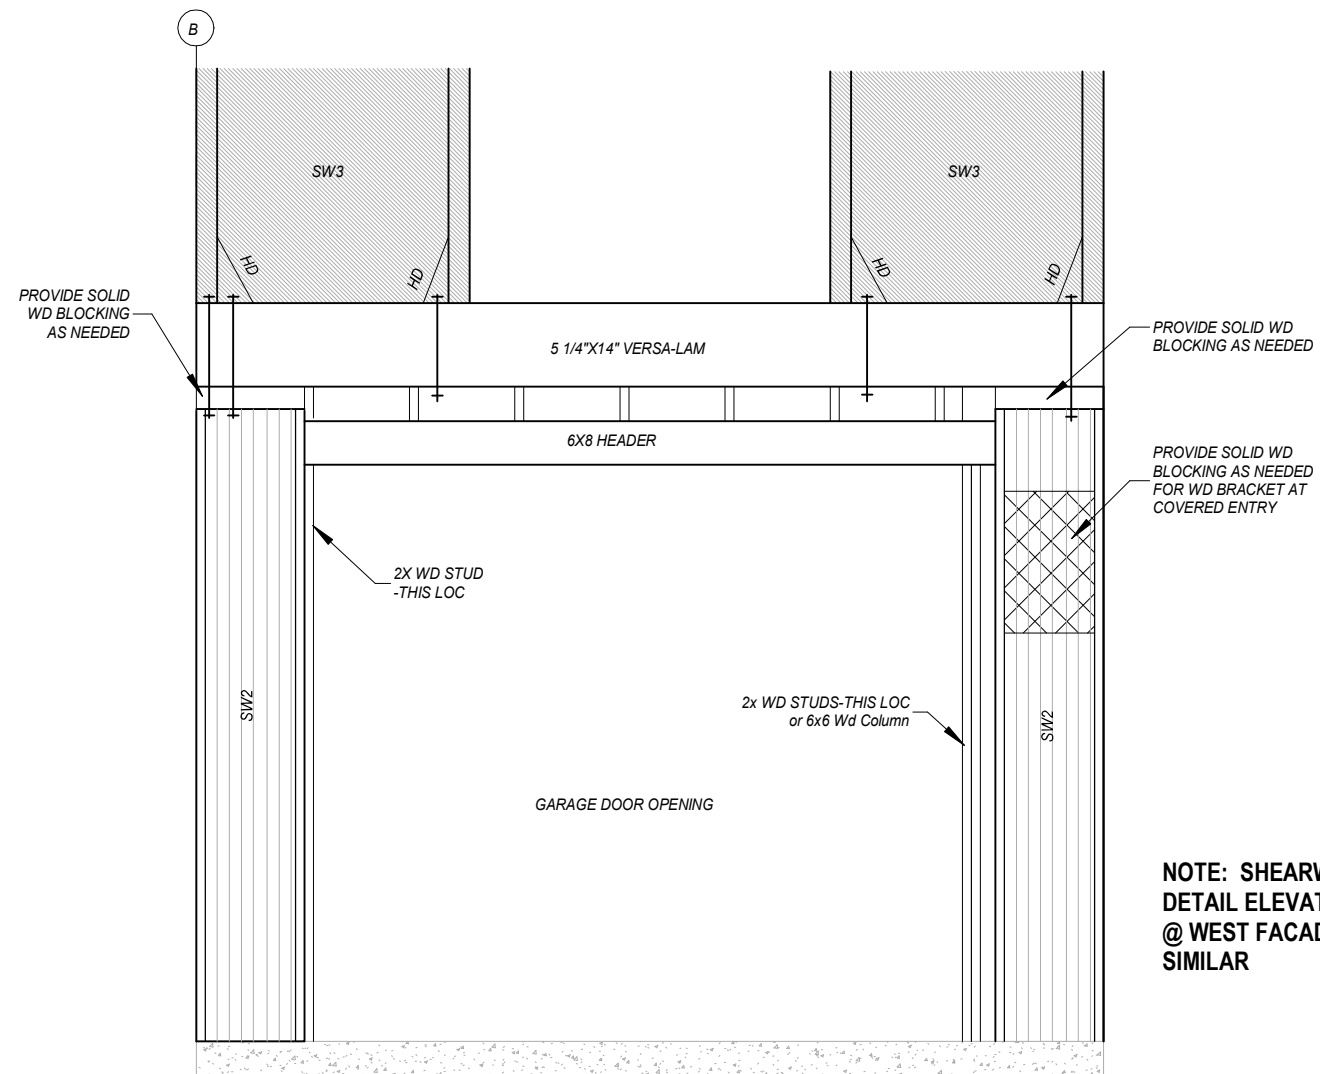
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Structural Details

S300

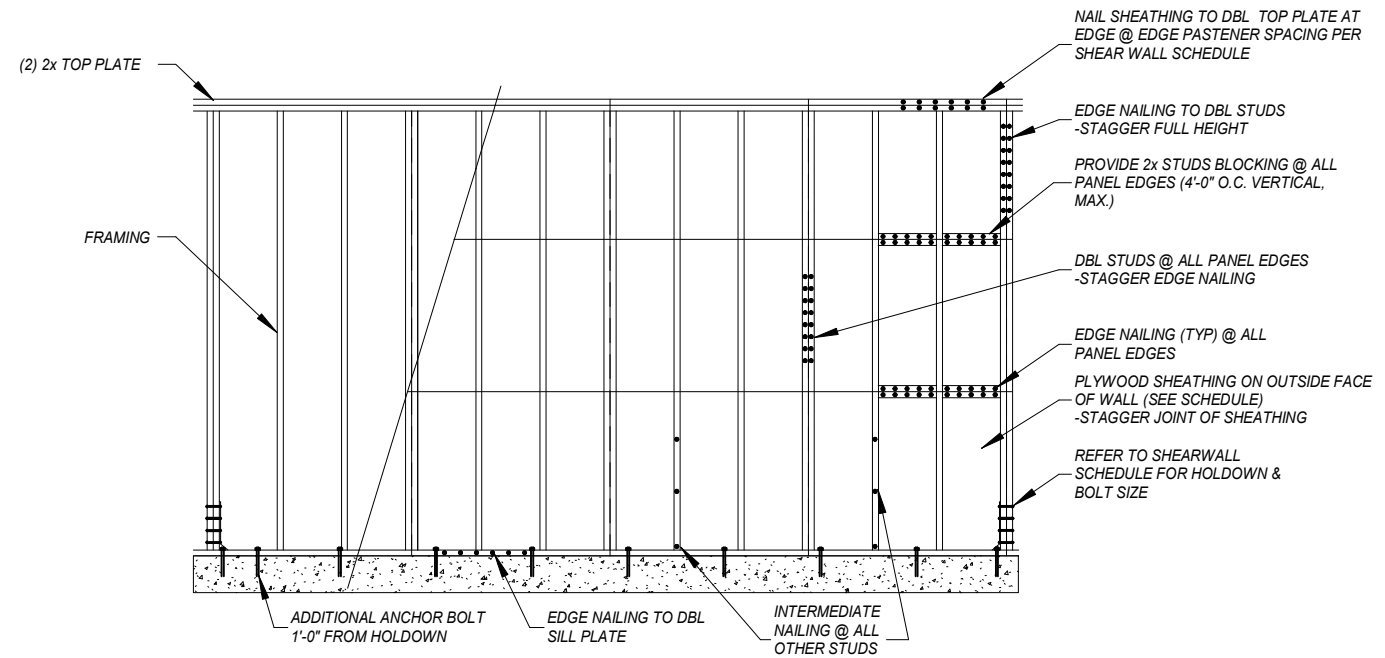
SHEET:
43 of 28



1 Typ. Column to Beam Connection
3/4" = 1'-0"




2 SHEARWALL DETAIL ELEVATION @ GARAGE
3/8" = 1'-0"




- EXTERIOR PLYWOOD SHEATHING SHALL BE APA RATED, STRUCTURAL 1.
- SEE SHEARWALL SCHEDULE FOR FASTENER SPACING REQUIREMENTS.
- STRUCTURAL PLYWOOD APA RATED SHEATHING PERMITTED TO BE APPLIED EITHER PARALLEL OR PERPENDICULAR TO FRAMING, STAGGER JOINT OF SHEATHING.
- FACE NAIL DOUBLE STUDS 16d AT 6" O.C. FOR SHEAR TRANSFER BETWEEN PANELS.
- ANCHOR BOLT FOR SILL PLATE TO BE 5/8" SIMPSON AT MIN. EMBEDMENT 7" AT 2 FOOT CENTERS, ANCHOR BOLTS TO BE SPACED AT 4 FOOT CENTERS AT NON-SHEARWALL LOCATIONS.

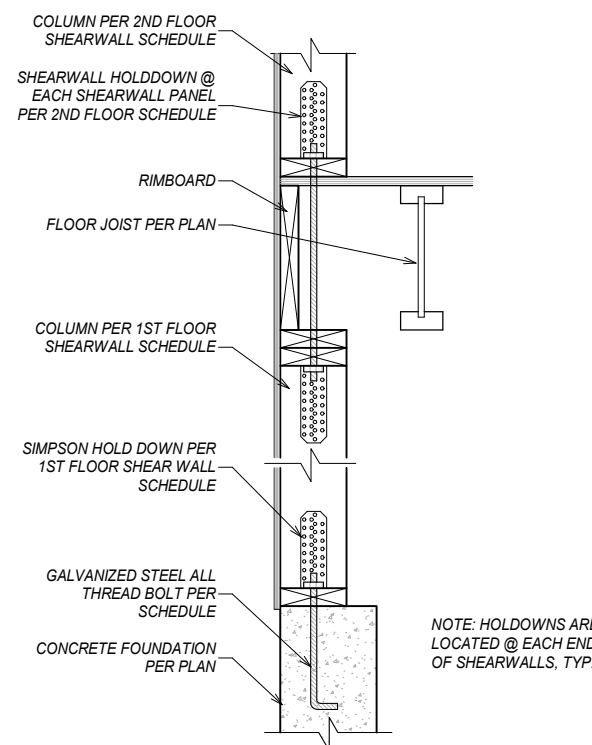3 Shearwall Detail
1/4" = 1'-0"



4 Shearwall Holdown Detail
3/4" = 1'-0"

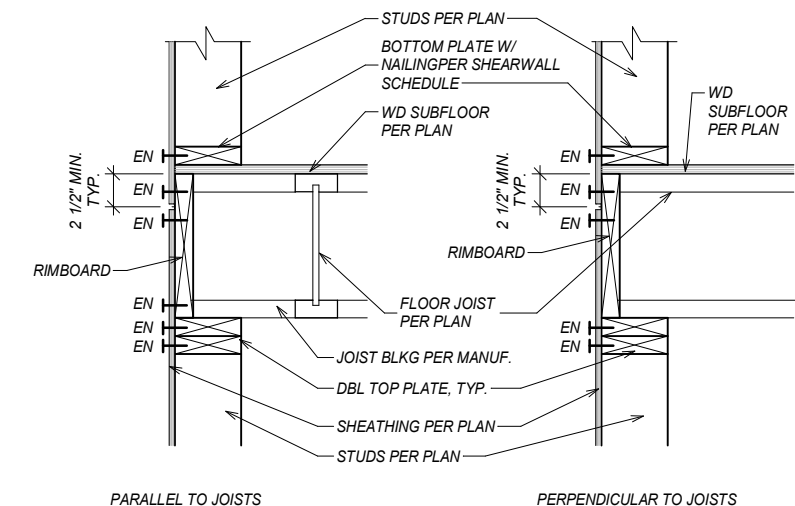

5 Edge Nailing Detail
3/4" = 1'-0"


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S301
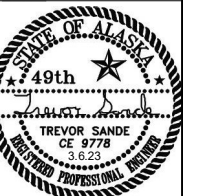
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